

# 

# AutoZone Store Development Plan Submission AutoZone-Oleander Store No. 6486 3913 Oleander Drive Wilmington, NC

Architect:

New Hanover County

AutoZone Development, LLC c/o: George Callow 123 S. Front Street, 3rd Floor Memphis, Tennessee 38103 (901) 495 - 8705

> Plan Submittal Date: September 29, 2015 October 21, 2015

TRAFFIC CONTROL NOTES:

TRAFFIC MUST BE MAINTAINED AT ALL TIMES AND TRAFFIC CONTROL MUST COMPLY WITH THE MANUAL OF UNIFORM TRAFFIC ALL LANES OF TRAFFIC ARE TO BE OPEN DURING THE HOURS OF 6:00 AM TO 9:00 AM AND FROM 4:00 PM TO 6:00 PM. A MINIMUM OF ONE 12-FOOT LANE SHALL BE MAINTAINED AT ALL TIMES.

ALL ROADWAY SIGNS WHICH ARE TO BE REMOVED DURING CONSTRUCTION ARE TO BE REINSTALLED AS SOON AS POSSIBLE. DURING NON-WORKING HOURS, EQUIPMENT IS TO BE PARKED AS CLOSE TO THE RIGHT OF WAY LINE AS POSSIBLE AND BE PROPERLY BARRICADED IN ORDER TO PREVENT ANY EQUIPMENT OBSTRUCTION WITHIN THE TRAVEL LANE. ALL CONTRACTORS DOING WORK WITHIN STATE RIGHT OF WAY ARE TO HAVE A COPY OF THESE PLANS ON THE JOB SITE WHEN PERSONNEL AND/OR EQUIPMENT ARE WITHIN 5' OF AN OPEN TRAVEL LANE, THE CONTRACTOR SHALL CLOSE THE OPEN RAVEL LANE ADJACENT TO THE WORK AREA USING APPROPRIATE TRAFFIC CONTROL MEANS AND METHODS UNLESS WORK IN THAT

THE CONTRACTOR SHALL NOT WORK SIMULTANEOUSLY ON BOTH SIDES OF AN OPEN TRAVEL WAY WITHIN THE SAME LOCATION ON A THE MAXIMUM LENGTH OF A LANE CLOSURE ON THE PROJECT SHALL BE ONE MILE, MEASURED FROM THE BEGINNING OF THE

THE CONTRACTOR SHALL BACKFILL AT 6:1 SLOPE UP TO THE EDGE AND ELEVATION OF EXISTING PAVEMENT IN AREAS ADJACENT TO AN OPENED TRAVEL LANE THAT HAS A DROP-OFF OF MORE THAN 3" WHEN BACKFILL IS REQUIRED, IT SHALL BE AT NO EXPENSE TO THE OWNER.

THE MAXIMUM DIFFERENCE IN ELEVATION BETWEEN OPEN LANES OF TRAFFIC SHALL BE 2"

WHEN LANE CLOSURES ARE NOT IN EFFECT, CHANNELING DEVICES IN WORK AREAS SHALL BE SPACED NO GREATER THAN TWICE DURING INSTALLATION, PROPER TRAFFIC CONTROL DEVICES, SIGNS, ETC. BE INSTALLED TO ENSURE PUBLIC SAFETY IN ACCORDANCE WITH THE NORTH CAROLINA DEPARTMENT OF TRANSPORTATION'S STANDARDS AND SPECIFICATIONS ALL DISTURBED AREAS ARE TO BE FULLY RESTORED TO NCDOT MINIMUM ROADWAY STANDARDS.

MATERIALS AND WORKMANSHIP SHALL CONFORM TO THE NCDOT ROADWAY STANDARDS AND SPECIFICATIONS (LATEST EDITION).

Prior to any clearing, grading or construction activity, tree protection fencing shall be installed around protected trees or 2. Any trees and/or areas designated to be protected must be properly barricaded with fencing and protected throughout construction to insure that no clearing, grading or staging of materials will occur in those areas. 3. No equipment is allowed on site until all tree protection fencing and silt fencing is installed and approved. Protective fencing is to be maintained throughout the duration of the project, and contractors shall receive adequate instruction on

4. All pavement markings in public rights-of-way and for driveways are to be thermoplastic and meet City and/or

5. Once streets are open to traffic, contact Traffic Engineering regarding the installation of traffic and street name signs. Proposed street names must be approved prior to installation of street name signs.

6. Traffic control devices (including signs and pavement markings) in areas open to public traffic are to meet 7. Contact Traffic Engineering at 910-341-7888 to ensure that all traffic signal facilities and equipment are shown on

8. Call Traffic Engineering at 910-341-7888 forty-eight (48) hours prior to any excavation in the right-of-way.

11. All traffic control signs and markings off the right-of-way are to be maintained by the property owner.

12. Stop signs and street signs to remain in place during construction.

13. Tactile warning mats will be installed on all wheelchair ramps.

17. Water and sewer service shall meet Cape Fear Public Utility Authority (CFPUA) details and specifications.

18, Project shall comply with CFPUA Cross Connection Control requirements. Water meter(s) cannot be released until all requirements are met and the State has given their final approval. Call 910-343-3910 for information 19. If the contractor desires CFPUA water for construction, he shall apply in advance for this service and must provide a reduced pressure zone (RPZ) backflow prevention device on the developer's side of the water meter box.

21. Any irrigation system shall be equipped with a rain and freezer sensor.

22. Any backflow prevention devices required by the CFPUA will need to be on the list of approved devices by USCFCCCHR

23. Contractor to field verify existing water and sewer service locations, sizes and materials prior to construction. Engineer to

24. Contractor shall maintain all-weather access for emergency vehicles at all times during construction.

Triangle Site Design, PLLC c/o: Matt Lowder, PE 4006 Barrett Drive, Suite 203 Raleigh, NC 27609 919 - 553 - 6570mlowder@trianglesitedesign.com

9. Traffic Engineering must approve of pavement marking prior to actual striping.

25. Underground fire line(s) must be permitted and inspected by the Wilmington Fire Department from the public right-of-way to the building. Contact the Wilmington Fire Department Division of Fire and Life Safety at 910-341-0696.

27. Contact the North Carolina One Call Center at 1-800-632-4949 prior to doing any digging, clearing, or grading

10. All parking stall markings and lane arrows within the parking areas shall be white.

14. A utility cut permit is required for each open cut of a city street.

15. Any broken or missing sidewalk panels, driveway panels and curbing will be replaced.

16. Contact Traffic Engineering at (910) 341-7888 to discuss street lighting options

20. Any irrigation system supplied by CFPUA water shall comply with the CFPUA Cross Connection Control regulations. Call 919-343-3910 for information.

26. No obstructions are permitted in the space between thirty (30) inches and ten (10) feet above the ground within the

Civil Engineering Plans Prepared by:

# INDEX OF DRAWINGS

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SITE DETAILS C1.A

GRADING & DRAINAGE PLAN C1.1

C1.2 UTILITY PLAN

C1.4

C1.3 EROSION CONTROL PLAN

C1.5STORMWATER MANAGEMENT DETAILS

CONSTRUCTION DETAILS

LANDSCAPE PLAN L1.0

DEMOLITION PLAN D1.0 LIGHTING PLAN LP1.0

ALTA/ACSM LAND TITLE SURVEY 1 of 2

ALTA/ACSM LAND TITLE SURVEY 2 of 2



Applicant / Future Property Owner:

AutoZone Development, LLC

c/o: Wade Davis

123 S. Front Street, 3rd Floor

Memphis, Tennessee 38103


(901) 495 - 8701

wade.davis@autozone.com



### EXISTING PROPERTY OWNERS: OLEANDER WEST LLC

JOSEPH STILWELL 10280 US HIGHWAY 17N WILMINGTON, NC 28422 910-233-4981

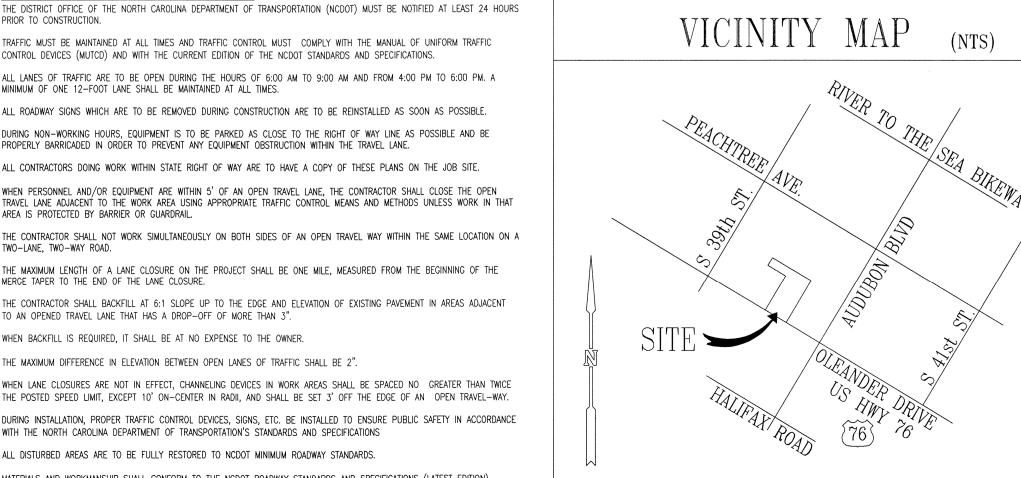


VICINITY MAP

4006 BARRETT DR, STE 203 RALEIGH, NC 27609 (919) 553-6570 ICENSE #P-0619

TRIANGLE SITE DESIGN, PLLC

**TRIANGLE** SITE DESIGN

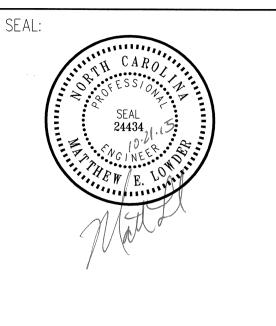

OWNER/DEVELOPER: AUTOZONE DEVELOPMENT, LLC ATTN. WADE DAVIS 123 S. FRONT STREET 3RD FLOOR MEMPHIS, TN 38103-2107 PHONE: (901) 495-8701 FAX: (901) 495-8969 wade.davis@autozone.com For Bidding & Contractor Information Contact: F.W. Dodge Plan Room Tel: (615) 884-1017

REVISIONS:


10/21/15 REVISED PER CITY OF WILMINGTON REVIEW COMMENTS

LAYOUT COORD: PLANNING MGR. DRAWING BY: SEPTEMBER 29, 2015 DATE: JOB NUMBER: 010048

TITLE:

COVER SHEET

SHEET NUMBER:

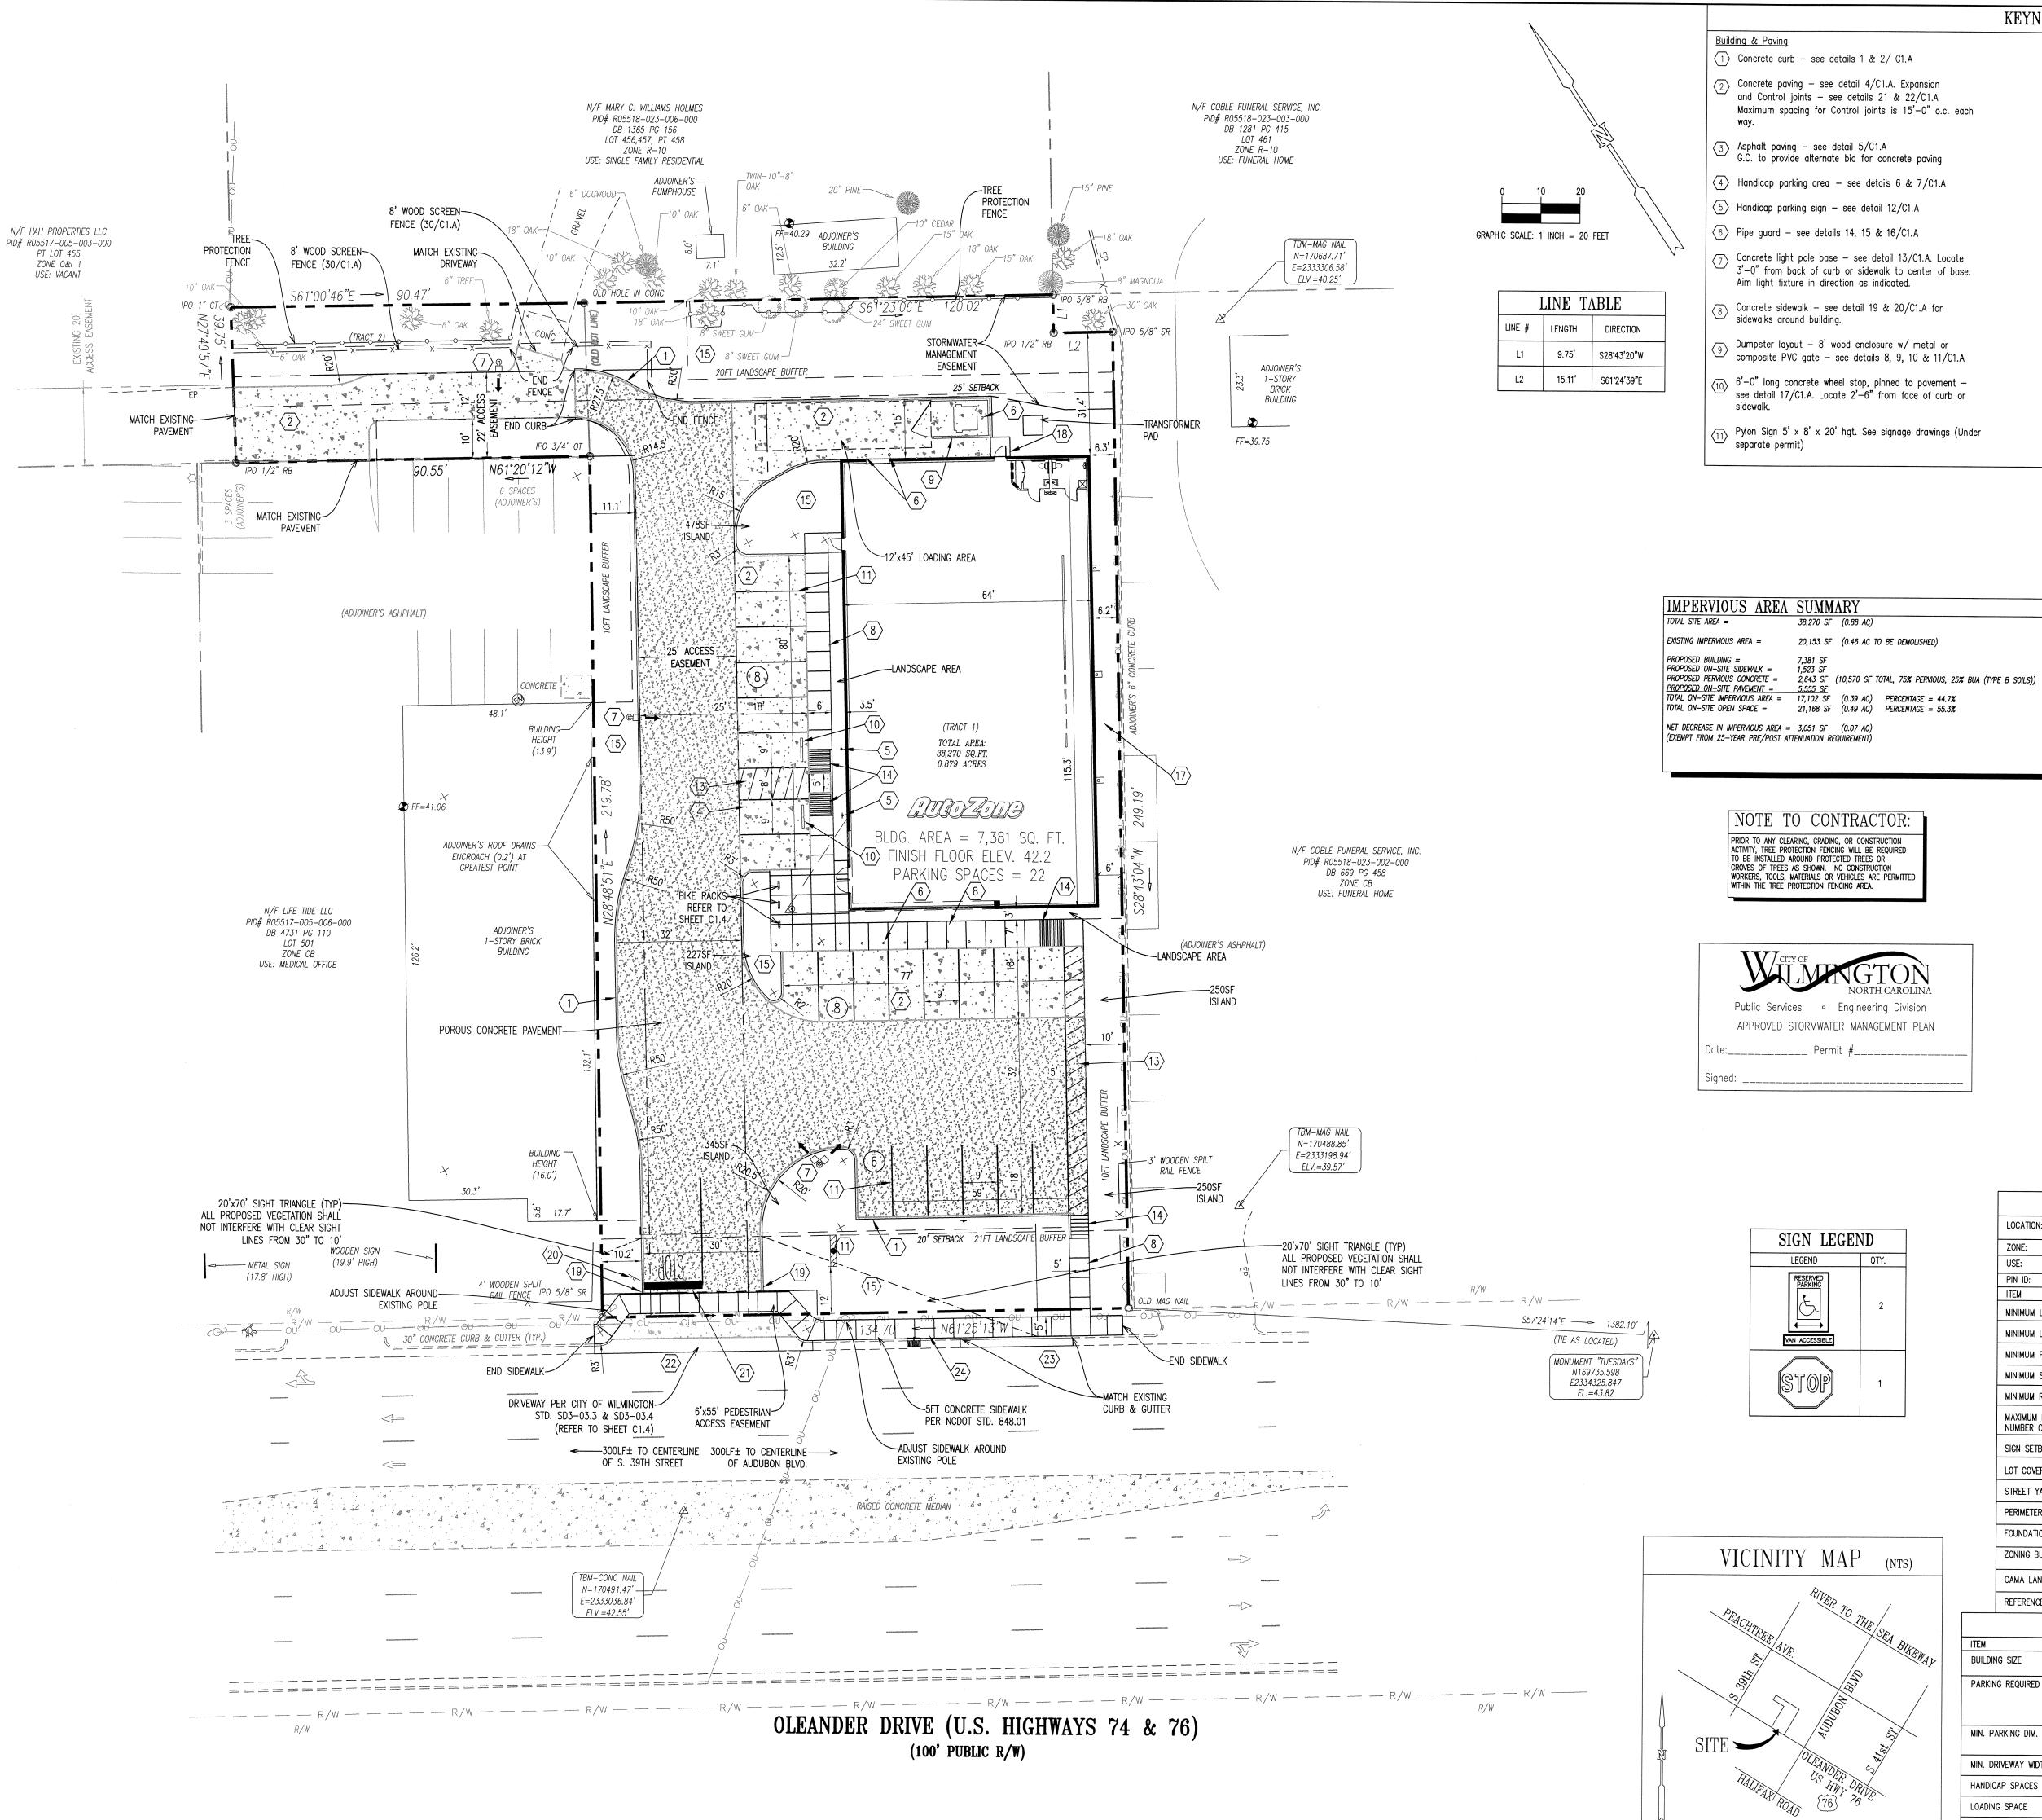

#### KEYNOTES

- - (1) Concrete curb see details 1 & 2/ C1.A (2) Concrete paving — see detail 4/C1.A. Expansion
  - and Control joints see details 21 & 22/C1.A Maximum spacing for Control joints is 15'-0" o.c. each
- 3 Asphalt paving see detail 5/C1.A G.C. to provide alternate bid for concrete paving
- $\langle 4 \rangle$  Handicap parking area see details 6 & 7/C1.A

- Concrete light pole base see detail 13/C1.A. Locate 3'-0" from back of curb or sidewalk to center of base. Aim light fixture in direction as indicated.
- Concrete sidewalk see detail 19 & 20/C1.A for
- sidewalks around building.
- $\frac{1}{100}$  6'-0" long concrete wheel stop, pinned to pavement see detail 17/C1.A. Locate 2'-6" from face of curb or
- Pylon Sign 5'  $\times$  8'  $\times$  20' hgt. See signage drawings (Under

- $\langle 12 \rangle$  4" wide parking stripe painted white (typ.)
- $\langle 14 \rangle$  Concrete handicap ramp maximum slope 1:12 (8.33%) (per A.D.A. requirements). Maximum cross slope 1:50

(13) 4" wide diagonal stripes painted white @ 2 ft. o.c.

- New landscape area provide sod and 3" topsoil see sheet L1.0 for additional information
- Slope grade from back of curb down to match the existing grade @ property line.
- (17) Connect building down spouts to storm drainage system
- (18) 5' x 5' concrete pad
- $\langle 19 \rangle$  Slope end of curb 4:1
- (20) Stop Sign see detail 26/C1.A
- (21) Pavement markings see detail 25 & 26/C1.A
- (22) New curb cut & approach per local codes & specs.
- (23) New concrete curb & gutter to meet all local & state D.O.T. requirements
- New sidewalk to meet all local & state D.O.T.

requirements

Remove existing curb, gutter, pavement, sidewalk and back fill per local & state D.O.T. requirements

#### GENERAL NOTES

Property line and right-of-way monuments shall not be disturbed by construction. If disturbed, they shall be reset to their original locations at the Contractor's expense by a Registered

- Proof Roll Building and all parking areas. Notify AutoZone Inc. of any unacceptable areas.
- Building dimensions shown on the Civil Engineering Plans are for reference purposes only, Contractor shall use the Architectural
- and Structural Plans for exact Building dimensions.
- All site dimensions are referenced to the face of curbs or edge of paving unless otherwise noted.
- All sidewalks, curb and gutter, street paving, curb cuts, driveway approaches, handicap ramps, etc. constructed outside the property line in the right-of-way shall conform to all municipal and/or State specifications and requirements.
- All disturbance incurred to any adjoining property due to construction or demolition shall be restored to the previous condition or better, and to the satisfaction of the City or State
- The Contractor shall provide As-Built records of all construction (including underground utilities) to AutoZone Inc. at the end of

#### PAVEMENT LEGEND

ASPHALT PAVING - SEE DETAIL 5/C1.A (ALTERNATE BID) CONCRETE PAVING - SEE DETAIL 4/C1.A

CONCRETE PAVING - SEE DETAIL 4/C1.A

POROUS CONCRETE PAVEMENT - SEE DETAIL SHEET C1.5

## BULK AREA REQUIREMENTS

LOCATION: 3913 OLEANDER DRIVE (US HWY 76) WILMINGTON, NORTH CAROLINA ZONE: CB (COMMUNITY BUSINESS) USE: RETAIL AUTO PARTS SALES PIN ID: R05518-023-001-000

REQUIREMENTS PROVIDED 0.5 AC 0.879 AC MINIMUM LOT AREA 80FT MINIMUM LOT FRONTAGE 102FT MINIMUM FRONT SETBACK MINIMUM SIDE SETBACK MINIMUM REAR SETBACK 25FT (ADJACENT RESIDENTIAL) | 25FT 45 FT (3 STORIES) 21FT± (1 STORY) MAXIMUM BUILDING HEIGHT NUMBER OF STORIES 10 FT SIGN SETBACK 30% 19.3% LOT COVERAGE (BUILDING) 20FT STREET YARD STREET YARD BUFFER 20FT STREET YARD PERIMETER PARKING BUFFER 10FT PARKING BUFFER 10FT PARKING BUFFER

12% OF BUILDING FACE AREA | 12% OF BUILDING FACE AREA

10FT WITH FENCE

10FT ADJACENT RESIDENTIAL | 20FT ADJACENT RESIDENTIAL ZONING BUFFER CAMA LAND USE CLASSIFICATION: DEVELOPED

FOUNDATION PLANTINGS

REFERENCE IS MADE TO THE CITY OF WILMINGTON ZONING ORDINANCE


PARKING INFORMATION			
ITEM	REQUIREMENTS	PROVIDED	
BUILDING SIZE	N/A	7,381 SF	
PARKING REQUIRED	MIN SPACES = 18 (1 SPACE/400 SF GFA) MAX SPACES = 37 (1 SPACE/200 SF GFA)	22 SPACES	
MIN. PARKING DIM.	8.5 FT x 18 FT	9 FT x 18 FT	
MIN. DRIVEWAY WIDTH	24 FT	25 FT	
HANDICAP SPACES	2 SPACE	2 SPACES	
LOADING SPACE	1 REQUIRED (12'x45')	1 SPACE	
BICYCLE SPACES	5 SPACES	5 SPACES	



CONSULTANT:

TRIANGLE

SITE DESIGN

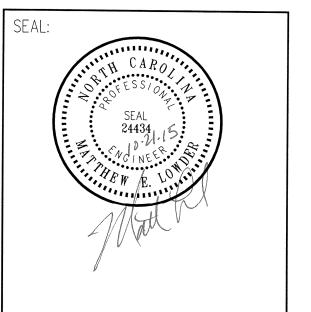

AutoZone-Olean Store Number: 3913 Oleander NC (92

OWNER/DEVELOPER: AUTOZONE DEVELOPMENT, LLC ATTN. WADE DAVIS 123 S. FRONT STREET 3RD FLOOR MEMPHIS, TN 38103-2107 PHONE: (901) 495-8701 FAX: (901) 495-8969 wade.davis@autozone.com For Bidding & Contractor Information Contact: F.W. Dodge Plan Room Tel: (615) 884-1017

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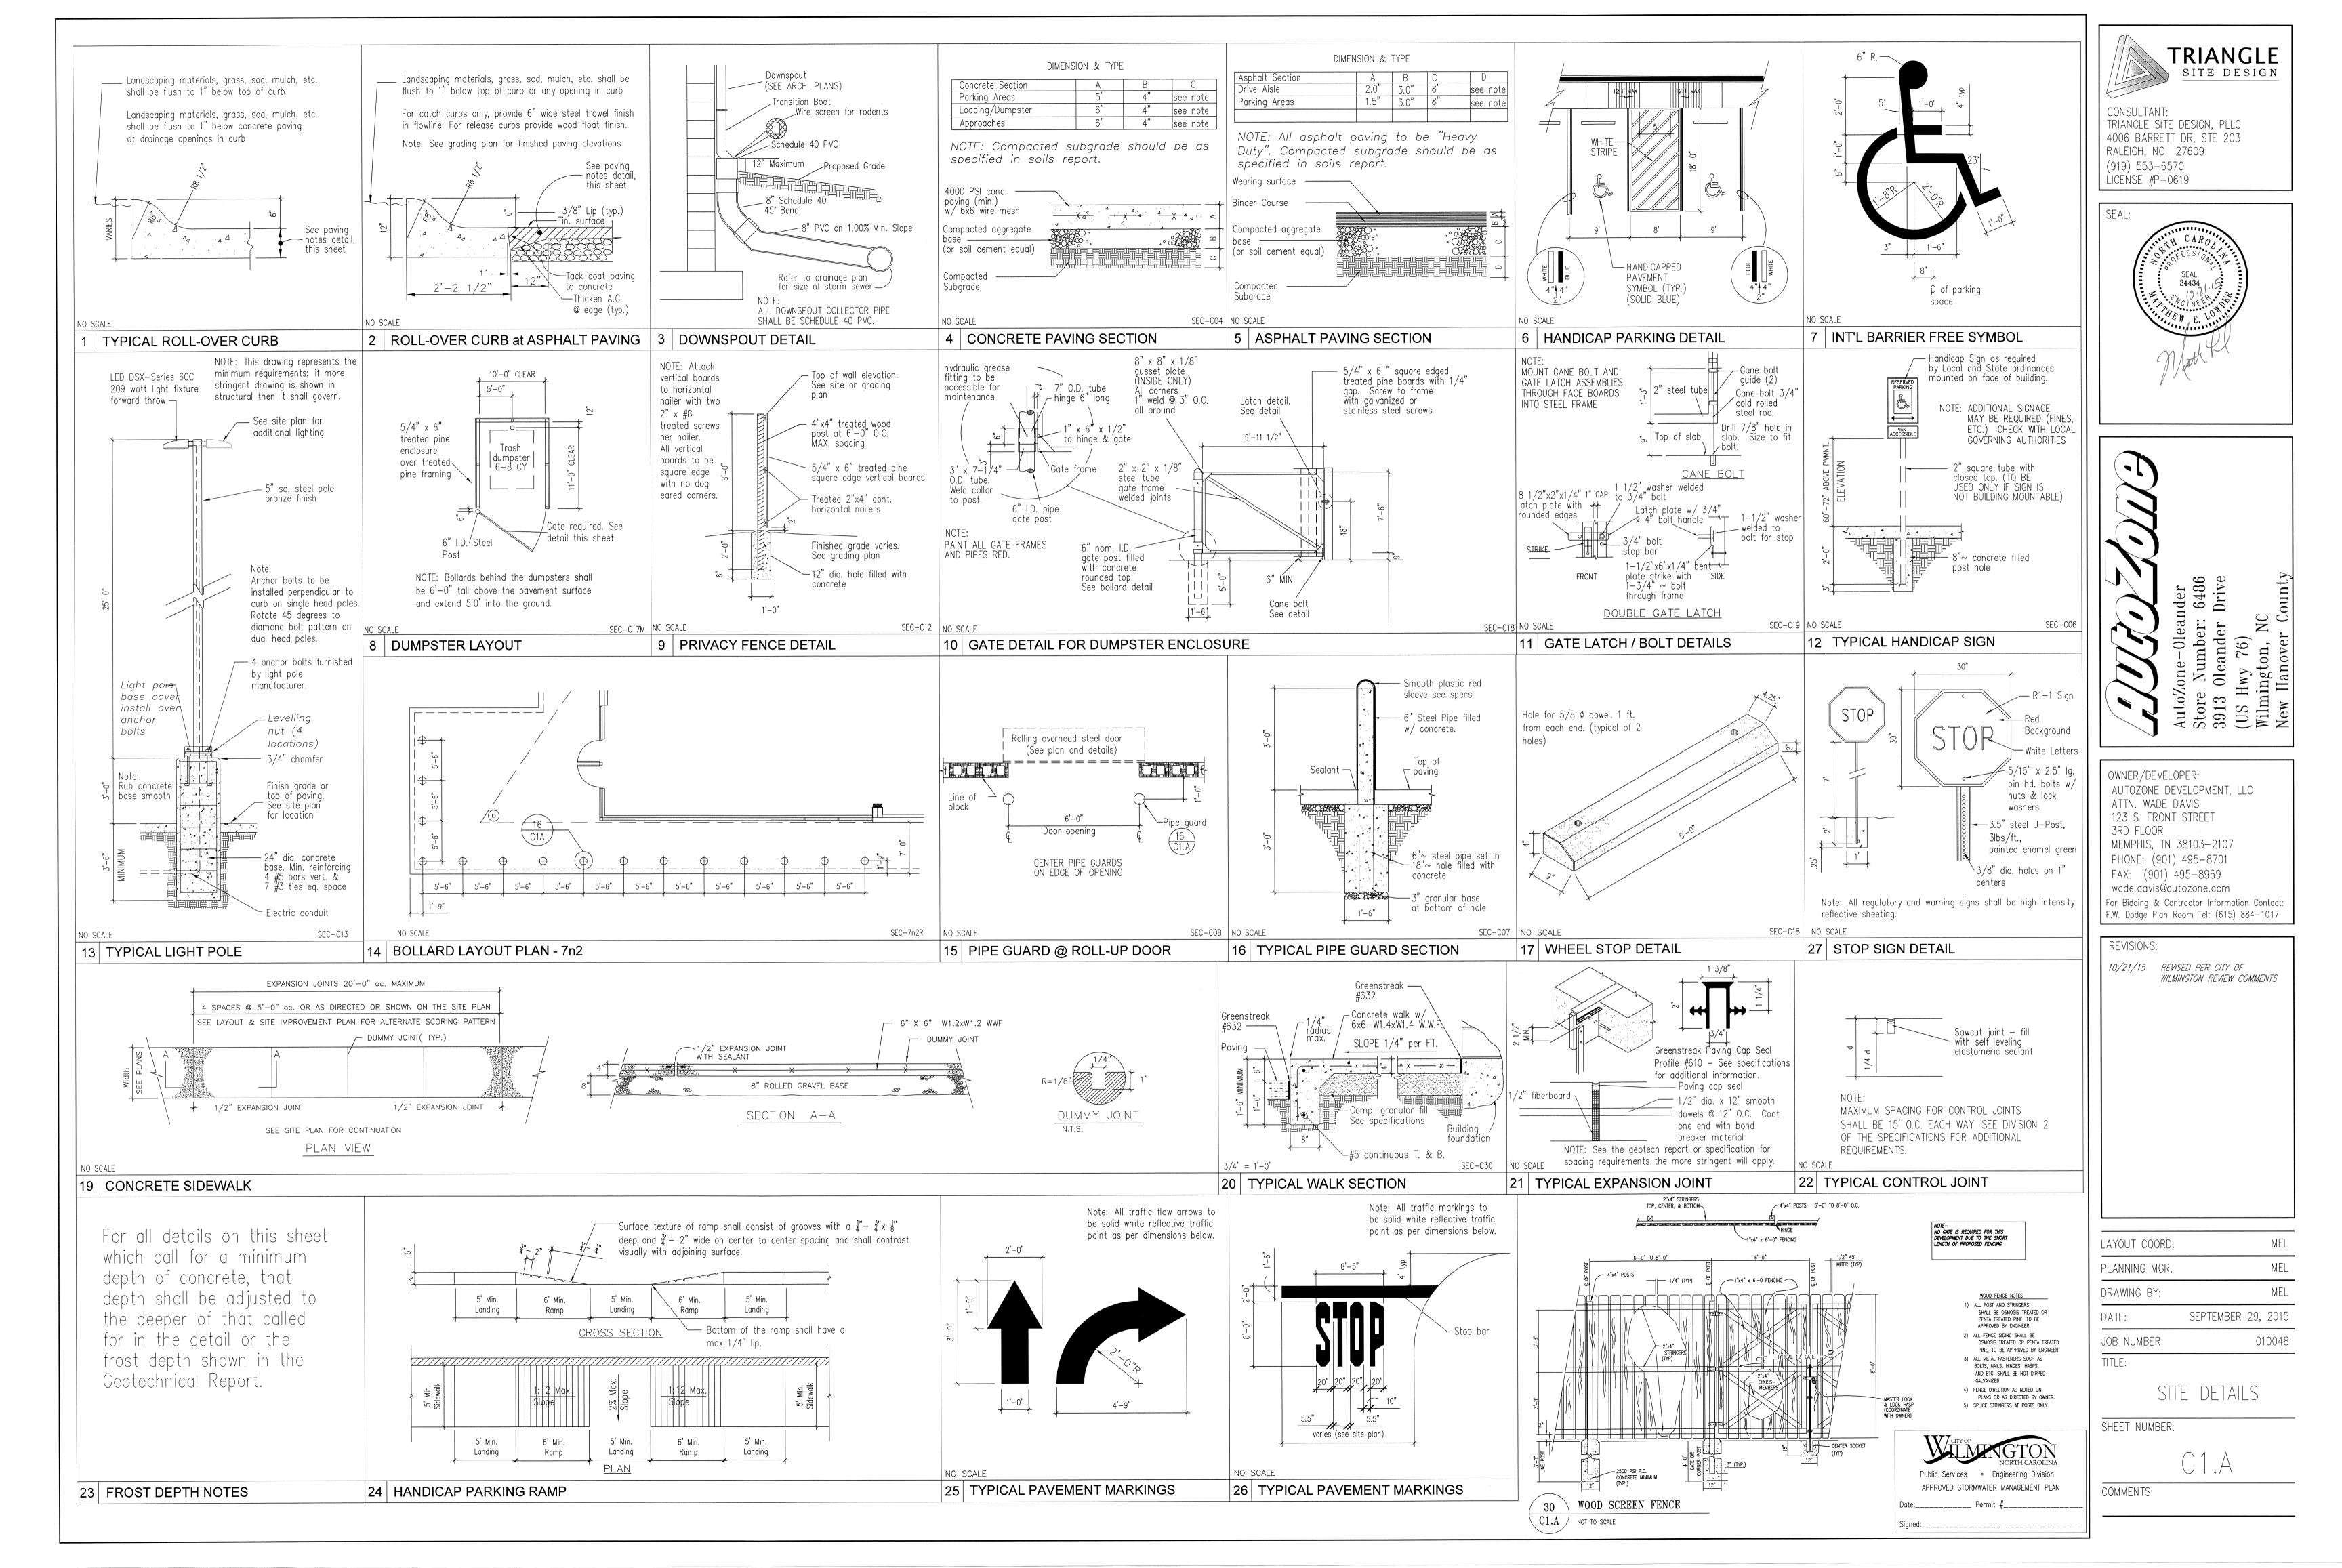
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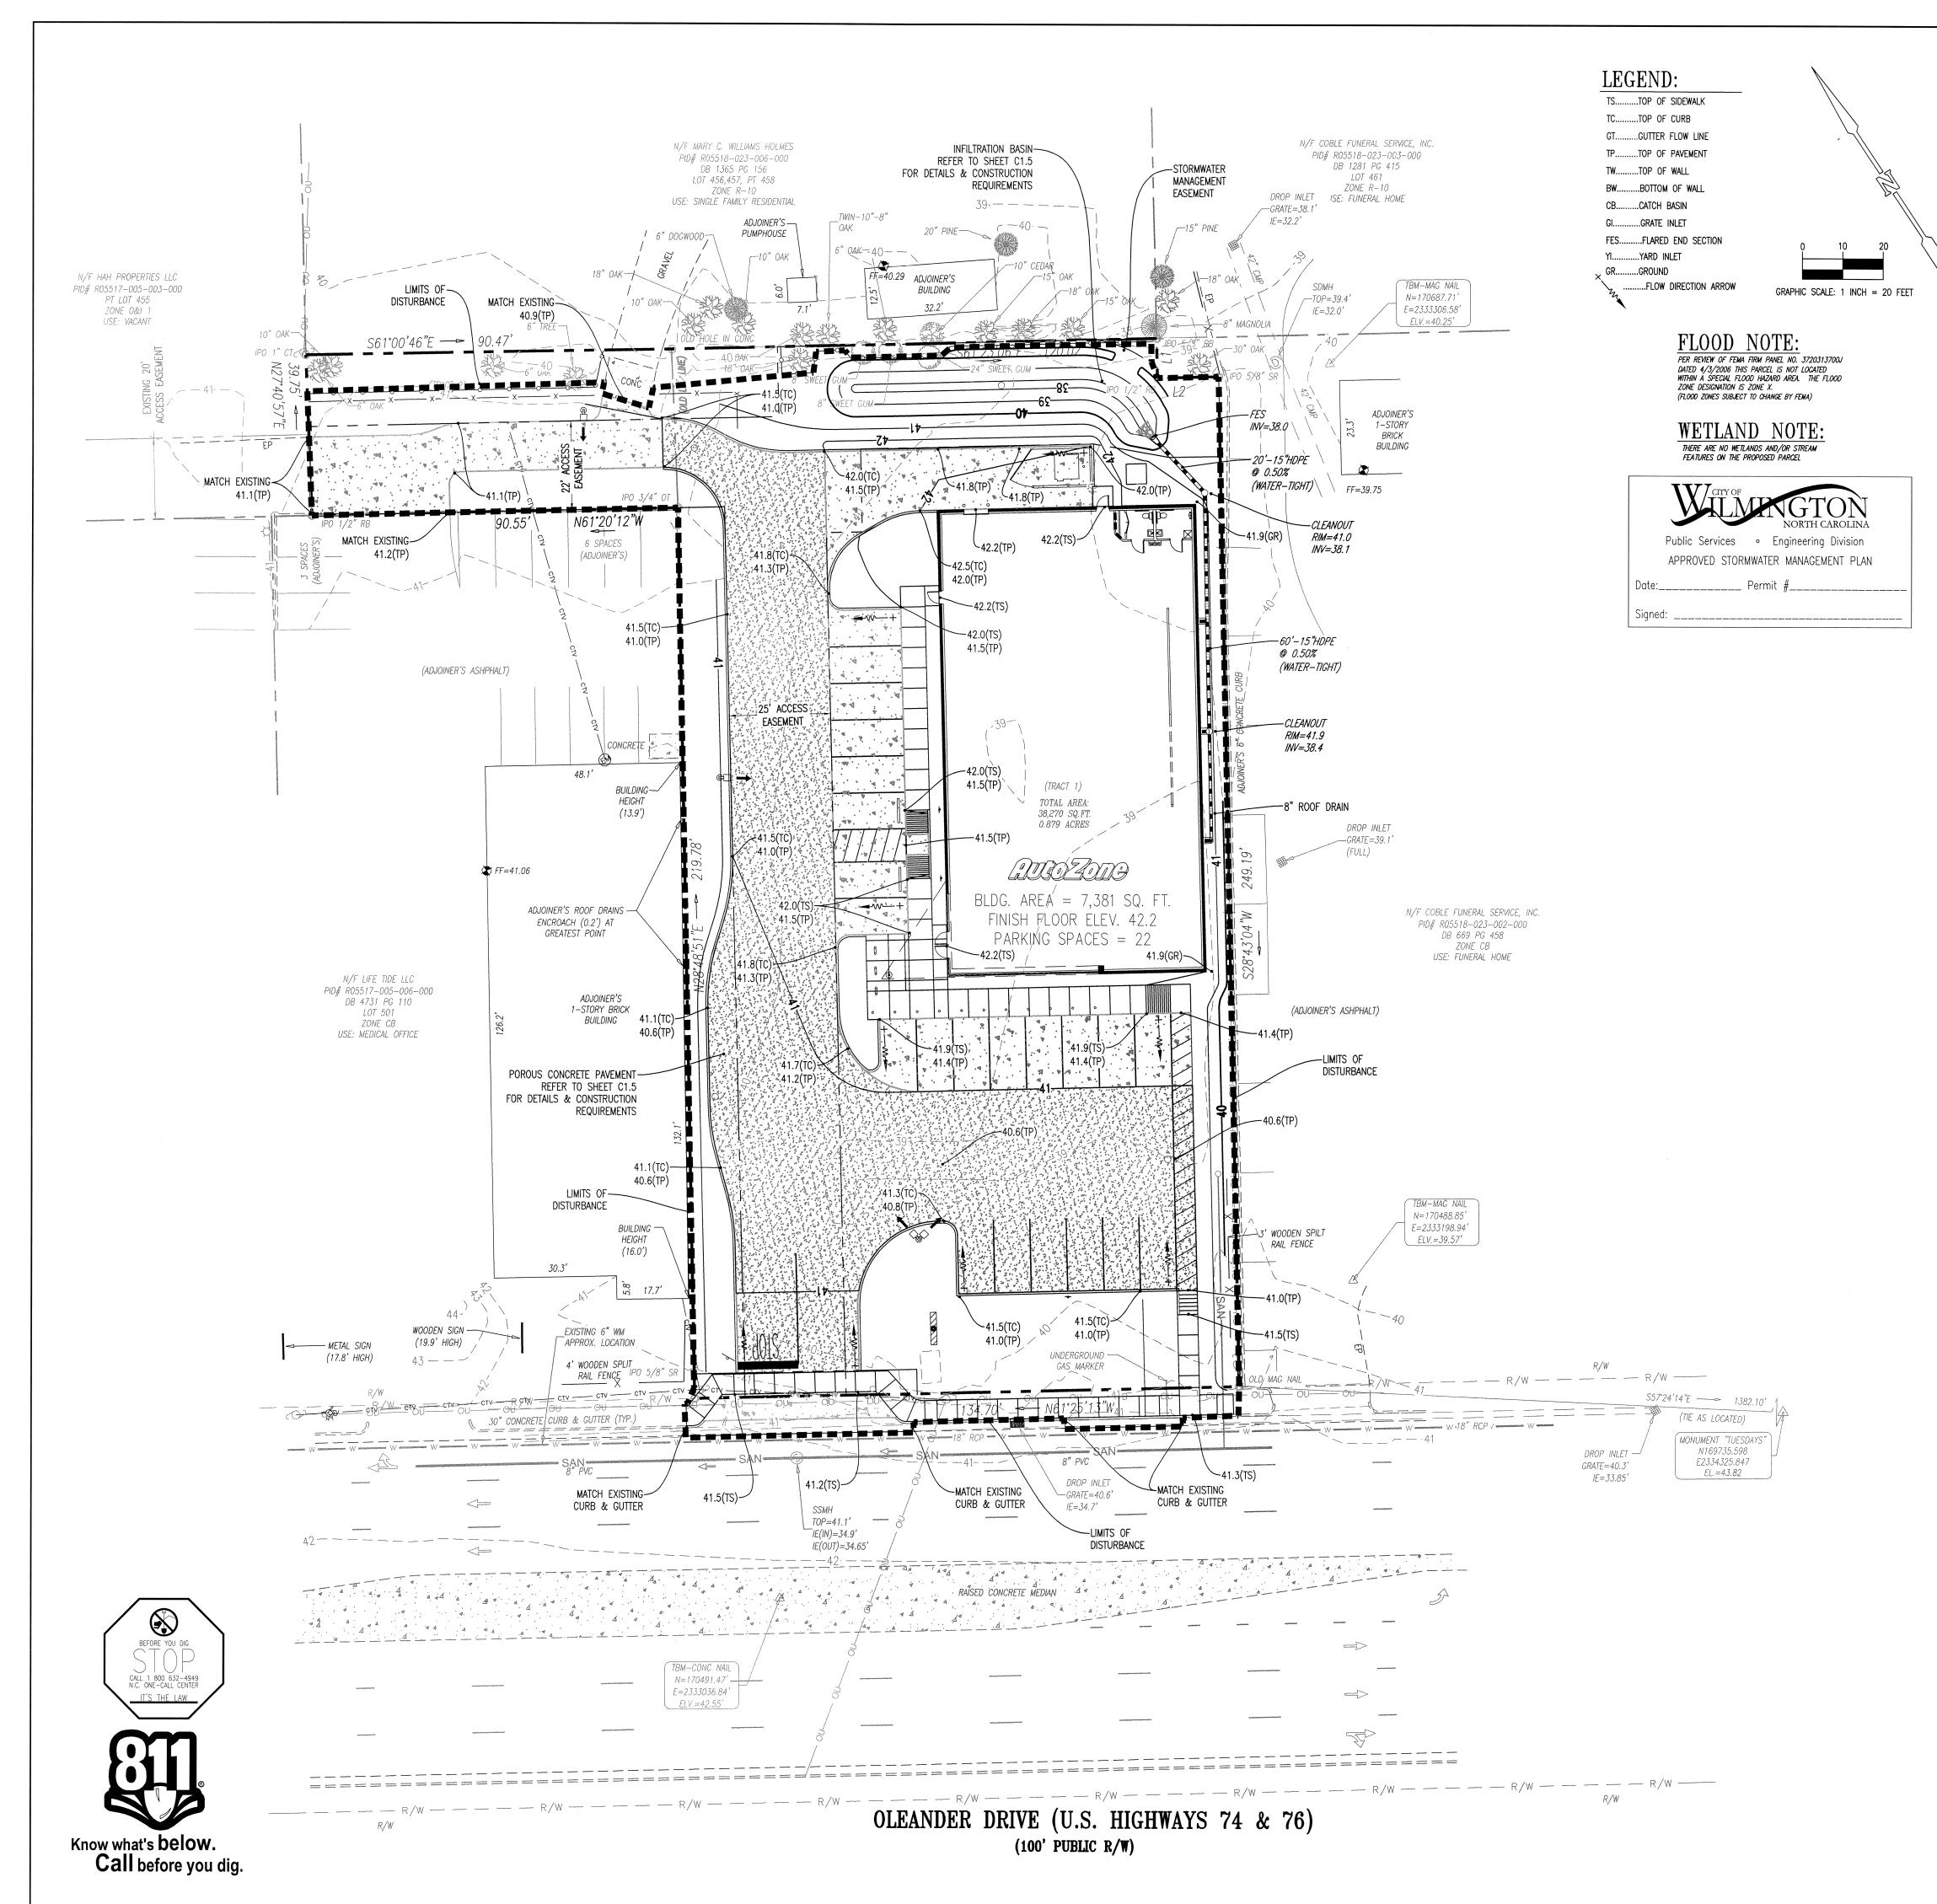
LAYOUT COORD:		MEL
PLANNING MGR.		MEL
DRAWING BY:		MEL
DATE:	SEPTEMBER 29,	2015

JOB NUMBER: 010048

SITE PLAN

SHEET NUMBER:






#### GRADING NOTES:

- 1. REFER TO THE SITE PLAN FOR RELATED NOTES.
  - 2. ALL CONTOURS AND SPOT ELEVATIONS REFLECT FINISHED GRADES. 3. ALL ELEVATIONS ARE IN REFERENCE TO THE BENCHMARK, AND THIS MUST BE VERIFIED BY THE GENERAL CONTRACTOR PRIOR TO
  - GROUND BREAKING. 4. THE CONTRACTOR SHALL IMMEDIATELY REPORT TO OWNER ANY DISCREPANCIES FOUND BETWEEN ACTUAL FIELD CONDITIONS AND
  - CONSTRUCTION DOCUMENTS AND SHALL WAIT FOR INSTRUCTION PRIOR TO PROCEEDING. 5. THE CONTRACTOR SHALL BE RESPONSIBLE FOR LOCATING AND PROTECTING EXISTING UTILITIES, AND SHALL REPAIR ALL DAMAGE TO
  - EXISTING UTILITIES THAT OCCUR DURING CONSTRUCTION.
  - 6. THE CONTRACTOR SHALL BLEND NEW EARTHWORK SMOOTHLY TO TRANSITION BACK TO EXISTING GRADE.
  - 7. LIMITS OF CLEARING SHOWN ON GRADING PLAN ARE BASED UPON THE APPROXIMATE CUT AND FILL SLOPE LIMITS, OR OTHER GRADING REQUIREMENTS.
  - 8. THE PROPOSED CONTOURS SHOWN IN DRIVES AND PARKING LOTS AND SIDEWALKS ARE FINISHED ELEVATIONS INCLUDING ASPHALT. REFER TO PAVEMENT CROSS SECTION DATA TO ESTABLISH CORRECT SUB-BASE OR AGGREGATE BASE COURSE ELEVATIONS TO BE COMPLETED UNDER THIS CONTRACT.
  - ). THE CONTRACTOR SHALL ENSURE POSITIVE DRAINAGE SO THAT RUNOFF WILL DRAIN BY GRAVITY FLOW ACROSS NEW PAVEMENT AREAS TO NEW OR EXISTING DRAINAGE INLETS OR SHEET OVERLAND.
  - 10. ANY GRADING, BEYOND THE LIMITS OF CONSTRUCTION AS SHOWN ON THE GRADING PLAN, IS SUBJECT TO A FINE.
  - 11. GRADING MORE THAN ONE ACRE WITHOUT AN APPROVED EROSION CONTROL PLAN IS SUBJECT TO A FINE.
  - 12. STABILIZATION IS THE BEST FORM OF EROSION CONTROL. TEMPORARY SEEDING IS NECESSARY TO ACHIEVE EROSION CONTROL ON DENUDED AREAS AND ESPECIALLY WHEN THE CONSTRUCTION SEQUENCE REQUIRES IT.
  - 13. ALL DISTURBED AREAS ARE TO BE SEEDED OR LANDSCAPED WITHIN 14 DAYS OF COMPLETION OF GRADING.
  - 14. EXISTING GRADES, CONTOURS, UTILITIES AND OTHER EXISTING FEATURES FROM FIELD RUN SURVEY.
  - 15. THE CONTRACTOR SHALL INCLUDE IN THE CONTRACT PRICE ANY DE-WATERING NECESSARY TO CONSTRUCT THE PROJECT AS SHOWN
  - 16. THE CONTRACTOR IS RESPONSIBLE FOR THE DESIGN AND IMPLEMENTATION OF ALL SHEETING, SHORING, BRACING AND SPECIAL EXCAVATION MEASURES REQUIRED TO MEET OSHA, FEDERAL, STATE, AND LOCAL REGULATIONS PURSUANT TO THE INSTALLATION OF THE WORK INDICATED ON THESE DRAWINGS. THE DESIGN ENGINEER ACCEPTS NO RESPONSIBILITY FOR THE DESIGN(S) TO INSTALL
  - 17. THE CONTRACTOR SHALL REFER TO THE ARCHITECTURAL PLANS FOR EXACT LOCATION, ELEVATION, AND DIMENSIONS OF EXIT DOORS, RAMPS, BUILDING DIMENSIONS, AND EXACT BUILDING UTILITY ENTRANCE LOCATIONS.
  - 18. ALL FILL MATERIALS, EXISTING BUILDING FOUNDATIONS, PAVEMENT AND UTILITY STRUCTURES, TOPSOIL, AND ANY OTHER DELETERIOUS MATERIALS SHALL BE COMPLETELY REMOVED FROM WITHIN THE BEARING ZONE BELOW THE STRUCTURE.
  - 19. ALL FOUNDATION EXCAVATION SHALL BE INSPECTED BY A QUALIFIED GEOTECHNICAL REPRESENTATIVE TO DETERMINE WHETHER UNSUITABLE MATERIAL MUST BE REMOVED. ALL UNDESIRABLE MATERIAL SHALL BE REMOVED, BACKFILLED AND COMPACTED AS REQUIRED BY THE GEOTECHNICAL REPRESENTATIVE.
  - 20. ALL CUT OR FILL SLOPES SHALL BE 3:1 OR FLATTER UNLESS OTHERWISE NOTED OR DEPICTED.
  - 21. THE CONTRACTOR SHALL ADHERE TO ALL TERMS & CONDITIONS AS OUTLINED IN THE GENERAL N.P.D.E.S PERMIT FOR STORM WATER DISCHARGE ASSOCIATED WITH CONSTRUCTION ACTIVITIES.
  - 22. CONTRACTOR SHALL ADJUST AND/OR CUT EXISTING PAVEMENT AS NECESSARY TO ASSURE A SMOOTH FIT AND CONTINUOUS GRADE.
  - 23. CONTRACTOR SHALL ENSURE POSITIVE DRAINAGE AWAY FROM BUILDINGS FOR ALL NATURAL AND PAVED AREAS.
  - 24. ALL UN-SURFACED AREAS DISTURBED BY GRADING OPERATION SHALL RECEIVE 4 INCHES OF TOPSOIL CONTRACTOR SHALL APPLY STABILIZATION FABRIC TO ALL SLOPES 3H:1V OR STEEPER.
  - 25. CONSTRUCTION SHALL COMPLY WITH ALL APPLICABLE GOVERNING CODES AND BE CONSTRUCTED TO SAME.

# TRIANGLE SITE DESIGN

CONSULTANT: RIANGLE SITE DESIGN, PLLC 4006 BARRETT DR, STE 203 RALEIGH, NC 27609 (919) 553-6570 LICENSE #P-0619

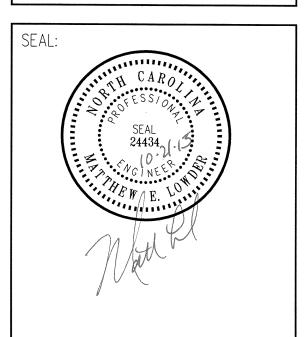

6480 Driv

OWNER/DEVELOPER: AUTOZONE DEVELOPMENT, LLC ATTN. WADE DAVIS 123 S. FRONT STREET 3RD FLOOR

MEMPHIS, TN 38103-2107 PHONE: (901) 495-8701 FAX: (901) 495-8969 wade.davis@autozone.com For Bidding & Contractor Information Contact: F.W. Dodge Plan Room Tel: (615) 884-1017

REVISIONS:

10/21/15 REVISED PER CITY OF WILMINGTON REVIEW COMMENTS

840.02 - CONCRETE CATCH BASIN 840.03 - FRAME, GRATES, AND HOOD FOR CATCH BASINS 840.04 - CONCRETE OPEN THROAT CATCH BASIN 840.14 - CONCRETE DROP INLET

4. CATCH BASINS, MANHOLES, FRAMES, GRATES, ETC. SHALL MEET THE REQUIREMENTS OF THE LATEST EDITION OF THE NORTH CAROLINA

C. EFFLUENT FROM DE-WATERING OPERATIONS SHALL BE FILTERED OR PASSED THROUGH AN APPROVED SEDIMENT TRAPPING

DEVICE, OR BOTH, AND DISCHARGED IN A MANNER THAT DOES NOT ADVERSELY AFFECT FLOWING STREAMS OR OFF-SITE

D. MATERIAL USED FOR BACK-FILLING TRENCHES SHALL BE PROPERLY COMPACTED IN ORDER TO MINIMIZE EROSION AND

E. RE-STABALIZATION SHALL BE ACCOMPLISHED IN ACCORDANCE WITH THE EROSION AND SEDIMENT CONTROL REGULATIONS.

840.16 - DROP INLET FRAME AND GRATES 840.35 — TRAFFIC BEARING GRATED DROP INLET 840.52 - PRECAST MANHOLE

F. APPLICABLE SAFETY REGULATIONS SHALL BE COMPLIED WITH.

1. A MINIMUM GRADE OF 0.50 % SHALL BE MAINTAINED ON ALL PIPES, UNLESS OTHERWISE NOTED.

B. EXCAVATED MATERIAL SHALL BE PLACED ON THE UPHILL SIDE OF TRENCHES.

2. PIPE LENGTHS AND SLOPES INDICATED ON THE PLANS ARE APPROXIMATE ONLY.

A. NO MORE THAN 500 LF OF TRENCH MAY BE OPENED AT ONE TIME.

DRAINAGE NOTES:

APPLICABLE CRITERIA:

PROMOTE STABILIZATION.

DEPARTMENT OF TRANSPORTATION STANDARD DRAWINGS. REFERENCE THE FOLLOWING STANDARD DETAILS: 840.31 - CONCRETE JUNCTION BOX 840.45 - PRECAST DRAINAGE STRUCTURE 838.80 - PRECAST CONCRETE ENDWALL

5. ALL PIPES SHALL BE LAID ON STRAIGHT ALIGNMENTS AND EVEN GRADES USING A PIPE LASER OR OTHER ACCURATE METHOD.

3. UNDERGROUND UTILITY LINES SHALL BE INSTALLED IN ACCORDANCE WITH THE FOLLOWING STANDARDS IN ADDITION TO OTHER


- 6. STORM PIPE SHALL BE AS FOLLOW UNLESS OTHERWISE NOTED: TYPE 1: RCP, CLASS III PER ASTM C-76, WITH FLEXIBLE PLASTIC BITUMEN GASKETS AT JOINTS. TYPE 2: HIGH DENSITY POLYETHYLENE PIPE (HDPE) - AASHTO DESIGNATION M252 TYPE S, M294 TYPE S AND MP7-97 TYPE S, SMOOTH INTERIOR/ANNULAR EXTERIOR. ONLY PERMITTED WHEN SPECIFICALLY INDICATED ON THE CONSTRUCTION DRAWINGS. PIPE SHALL BE INSTALLED IN ACCORDANCE WITH PIPE MANUFACTURER'S INSTALLATION GUIDELINES. PIPE JOINTS AND FITTINGS SHALL BE WATERTIGHT.
- 7. ALL STORM DRAINAGE WITHIN THE PUBLIC ROADS SHALL BE CLASS III REINFORCED CONCRETE PIPE UNLESS OTHERWISE NOTED.
- 8. EXISTING DRAINAGE STRUCTURES TO BE INSPECTED AND REPAIRED AS NEEDED, AND EXISTING PIPES TO BE CLEANED OUT TO REMOVE SILT AND DEBRIS.
- 9. IF ANY EXISTING STRUCTURES TO REMAIN ARE DAMAGED DURING CONSTRUCTION IT SHALL BE THE CONTRACTORS RESPONSIBILITY TO REPAIR AND/OR REPLACE THE EXISTING STRUCTURE AS NECESSARY TO RETURN IT TO EXISTING CONDITIONS OR BETTER.
- 10. ALL STORM PIPE ENTERING STRUCTURES SHALL BE GROUTED TO ASSURE CONNECTION AT STRUCTURE IS WATERTIGHT.
- 11. PRECAST STRUCTURES MAYBE USED AT CONTRACTORS OPTION.
- 12. ALL STORM SEWER MANHOLES IN PAVED AREAS SHALL BE FLUSH WITH PAVEMENT, AND SHALL HAVE TRAFFIC BEARING RING & COVERS. MANHOLES IN UNPAVED AREAS SHALL BE 6" ABOVE FINISH GRADE. LIDS SHALL BE LABELED "STORM SEWER".
- 13. STRUCTURE TOP ELEVATIONS SHOWN HERE ARE APPROXIMATE. CONTRACTOR SHALL ADJUST AS NECESSARY.
- 14. RIM ELEVATIONS AS NOTED ARE TO THE GUTTER FLOW LINE.

LAYOUT COORD: PLANNING MGR. DRAWING BY: SEPTEMBER 29, 2015 DATE: JOB NUMBER: 010048

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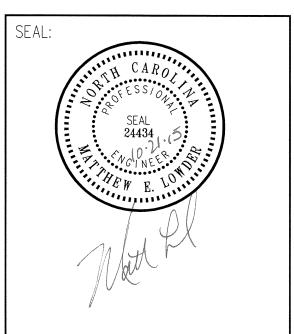




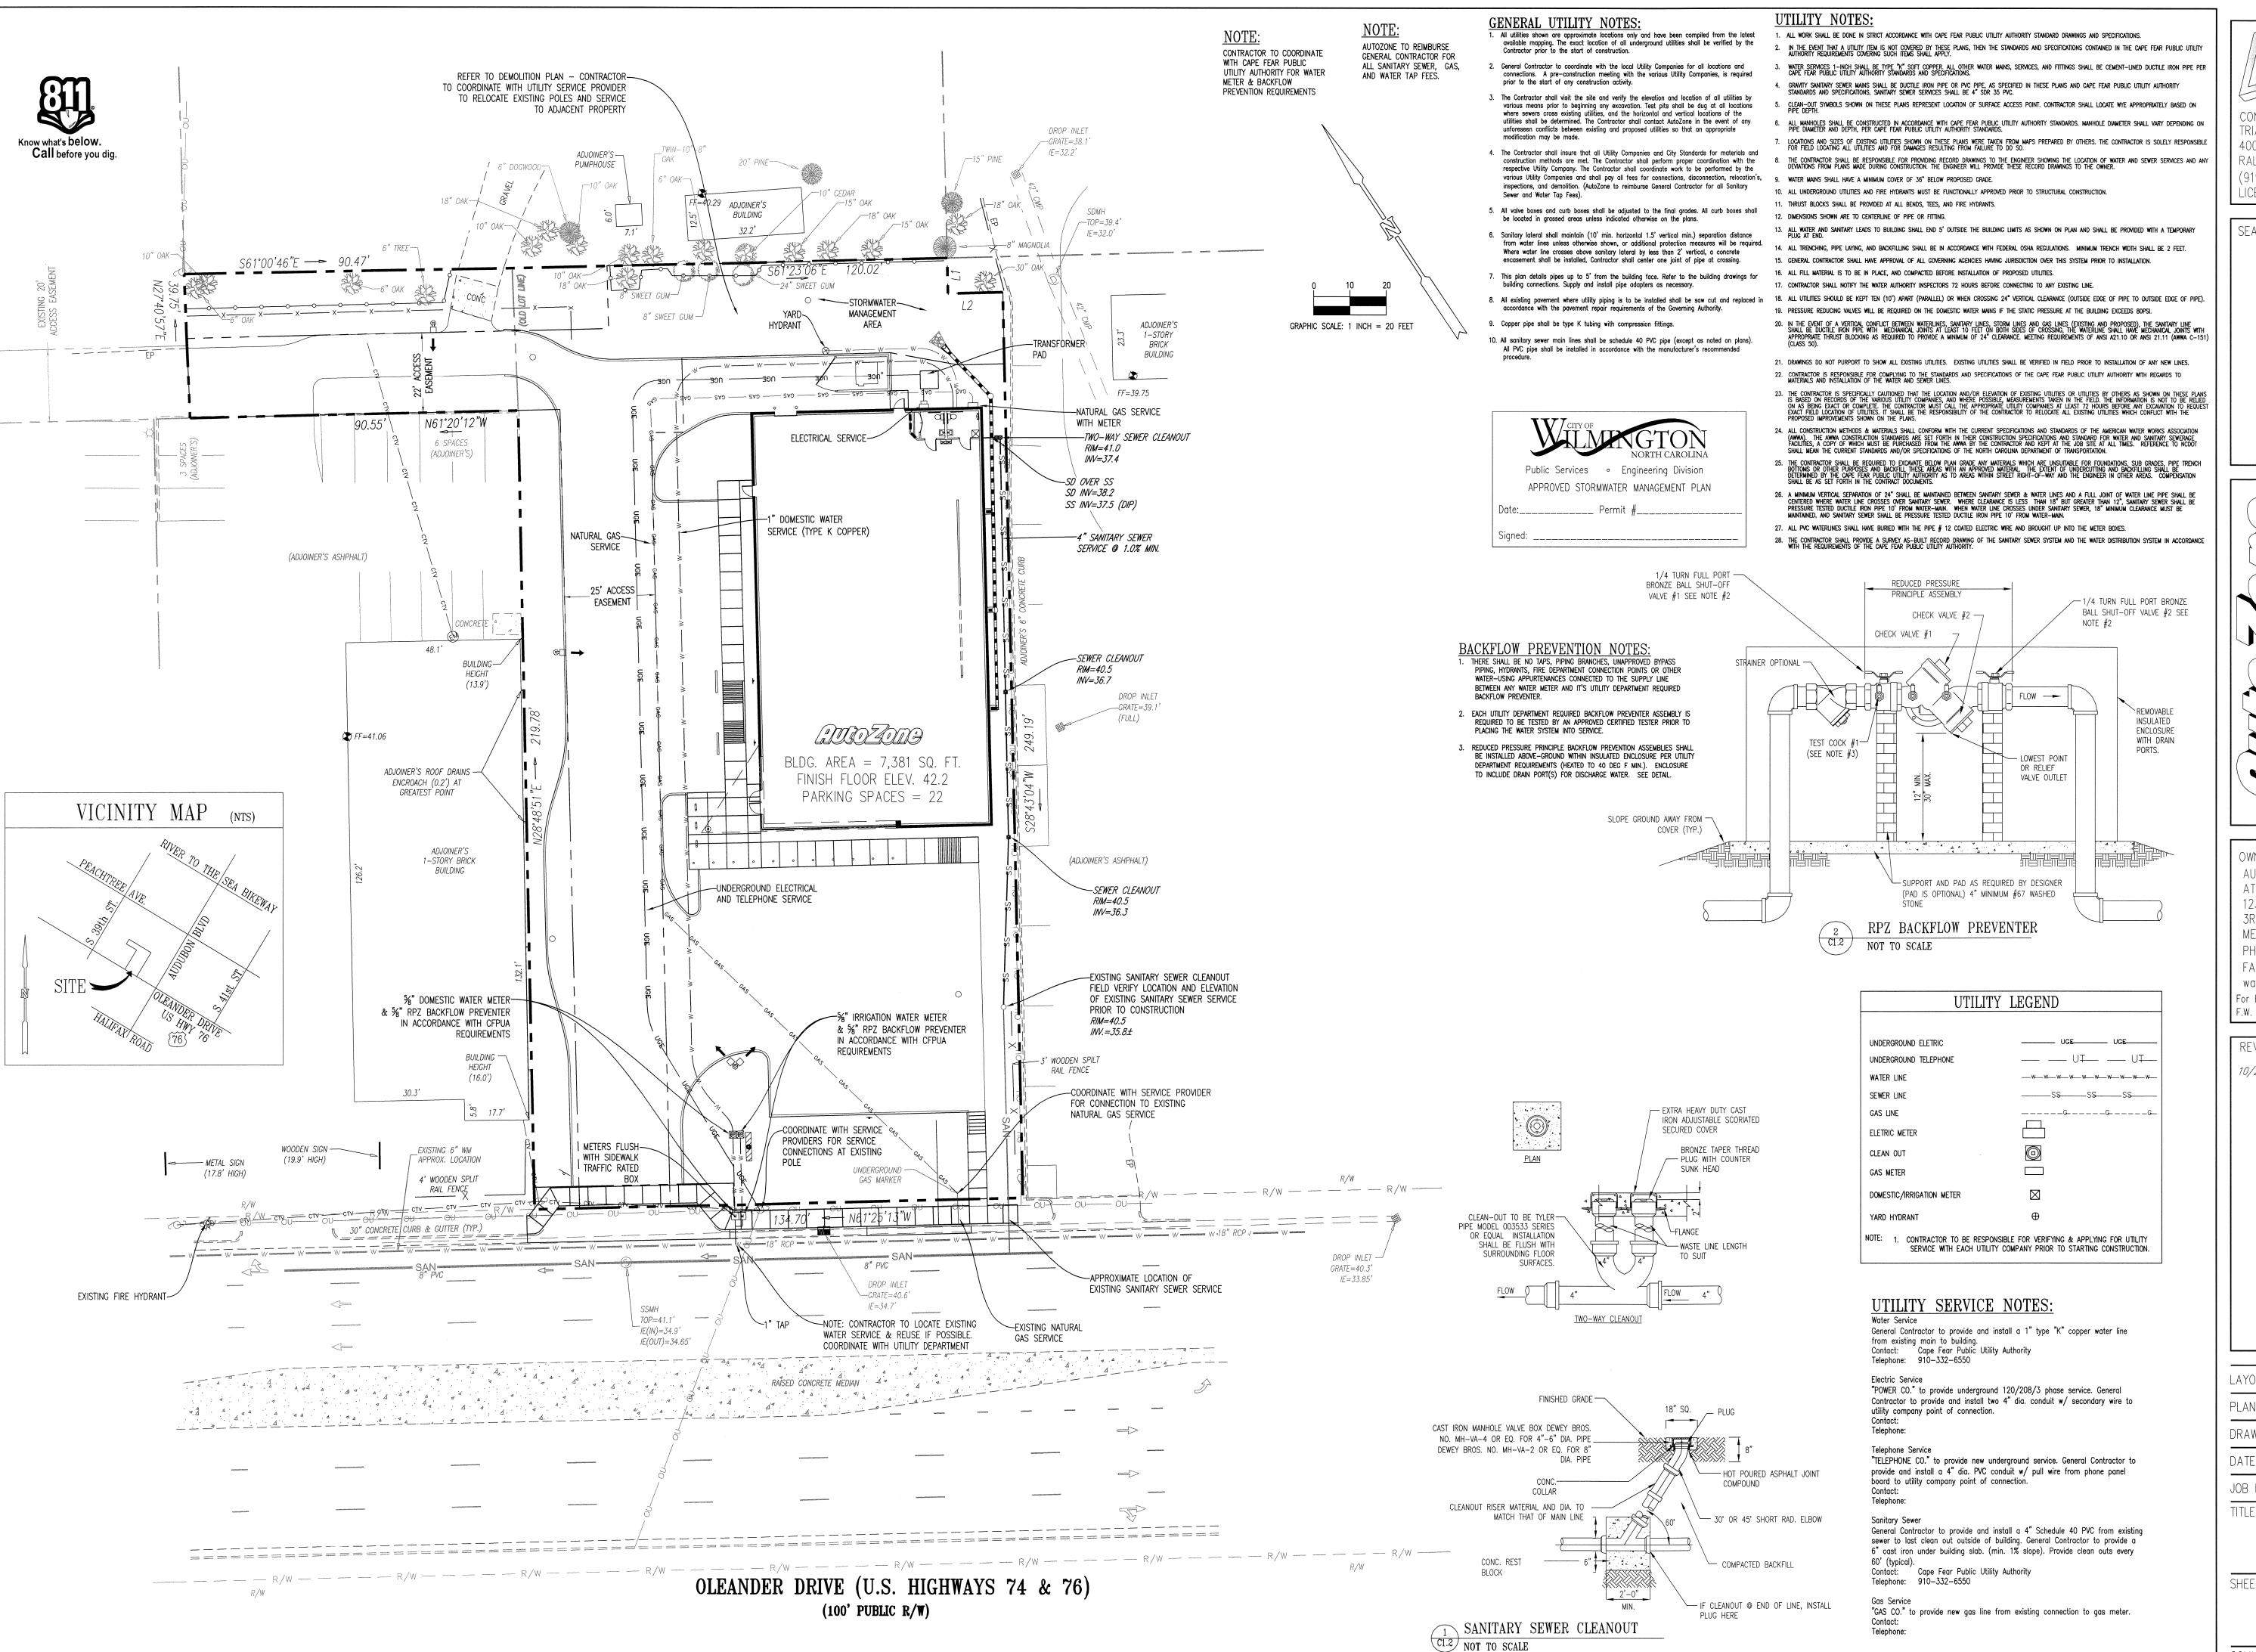

CONSULTANT:
TRIANGLE SITE DESIGN, P

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ne-Oleander
Number: 6486
Ileander Drive

OWNER/DEVELOPER:
AUTOZONE DEVELOPMENT, LLC
ATTN. WADE DAVIS
123 S. FRONT STREET
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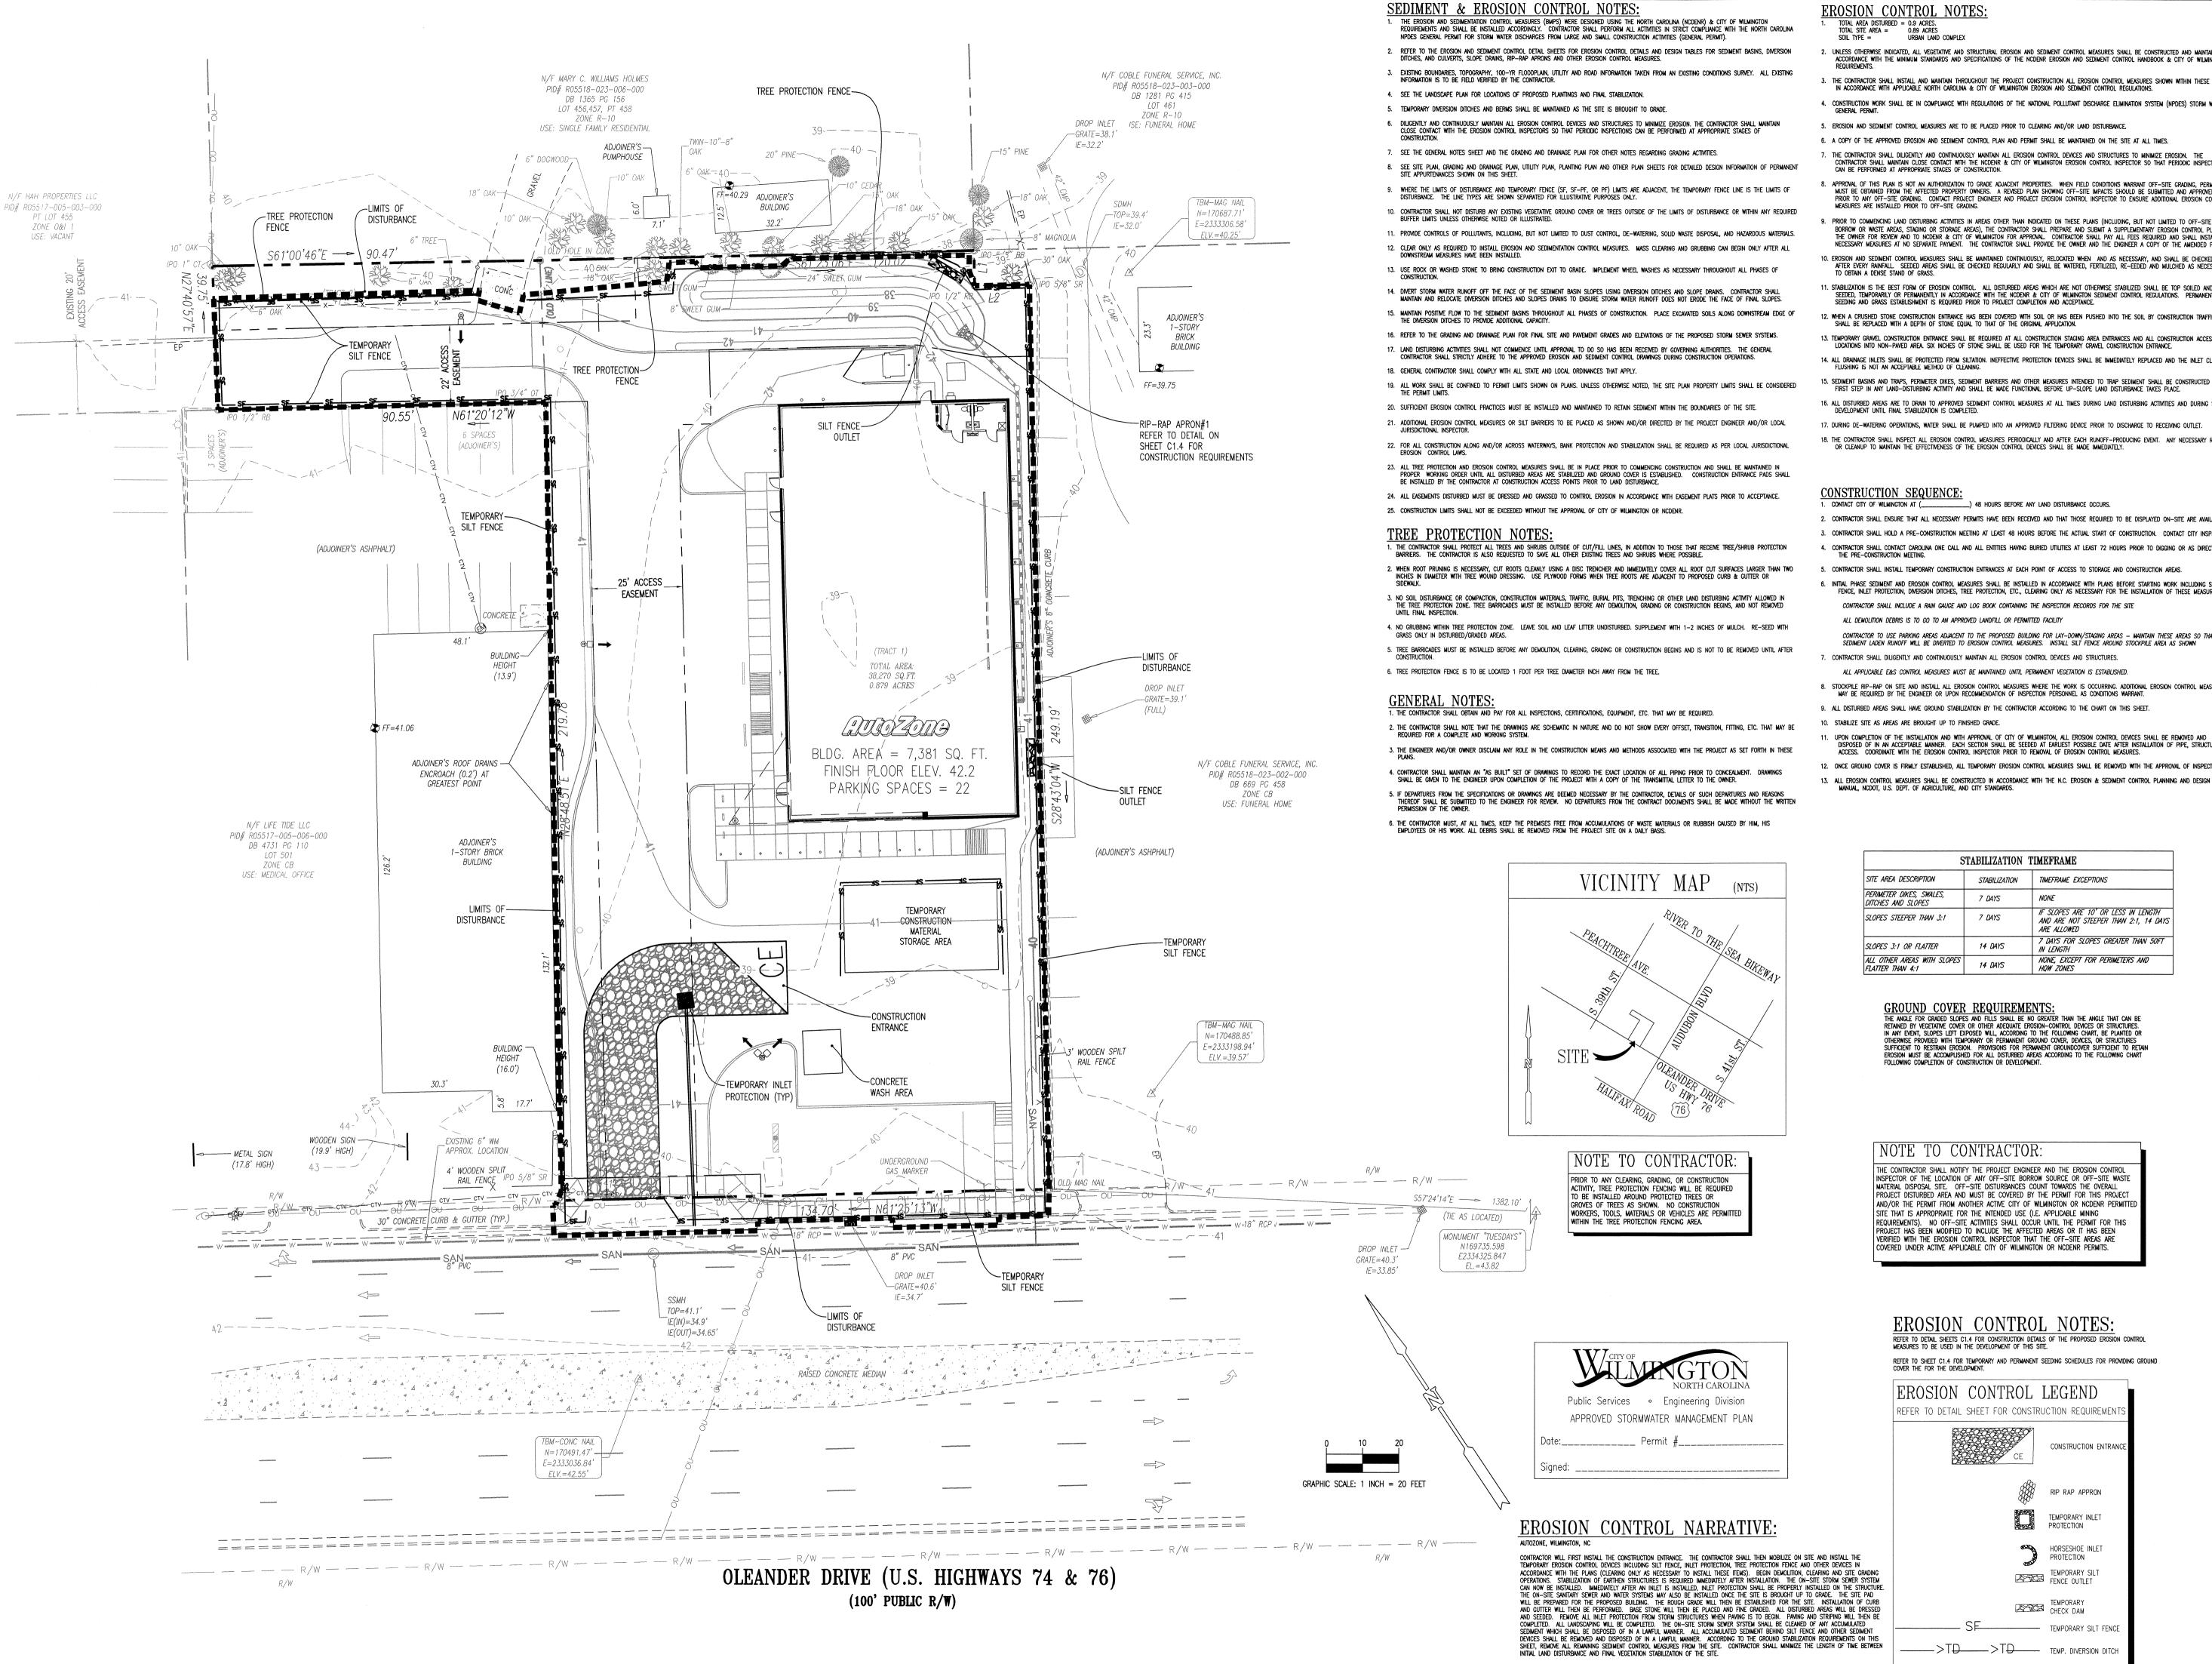
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LAYOUT COORD: MEL
PLANNING MGR. MEL
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TITLE:

UTILITY PLAN

SHEET NUMBER:

01.2



TOTAL AREA DISTURBED = 0.9 ACRES
TOTAL SITE AREA = 0.89 ACRES SOIL TYPE =

ACCORDANCE WITH THE MINIMUM STANDARDS AND SPECIFICATIONS OF THE NCDENR EROSION AND SEDIMENT CONTROL HANDBOOK & CITY OF WILMINGTON

- 3. THE CONTRACTOR SHALL INSTALL AND MAINTAIN THROUGHOUT THE PROJECT CONSTRUCTION ALL EROSION CONTROL MEASURES SHOWN WITHIN THESE PLANS IN ACCORDANCE WITH APPLICABLE NORTH CAROLINA & CITY OF WILMINGTON EROSION AND SEDIMENT CONTROL REGULATIONS.
- 4. CONSTRUCTION WORK SHALL BE IN COMPLIANCE WITH REGULATIONS OF THE NATIONAL POLLUTANT DISCHARGE ELIMINATION SYSTEM (NPDES) STORM WATER
- 5. EROSION AND SEDIMENT CONTROL MEASURES ARE TO BE PLACED PRIOR TO CLEARING AND/OR LAND DISTURBANCE.
- 6. A COPY OF THE APPROVED EROSION AND SEDIMENT CONTROL PLAN AND PERMIT SHALL BE MAINTAINED ON THE SITE AT ALL TIMES
- CONTRACTOR SHALL MAINTAIN CLOSE CONTACT WITH THE NODENR & CITY OF WILMINGTON EROSION CONTROL INSPECTOR SO THAT PERIODIC INSPECTIONS CAN BE PERFORMED AT APPROPRIATE STAGES OF CONSTRUCTION. APPROVAL OF THIS PLAN IS NOT AN AUTHORIZATION TO GRADE ADJACENT PROPERTIES. WHEN FIELD CONDITIONS WARRANT OFF-SITE GRADING, PERMISSION MUST BE OBTAINED FROM THE AFFECTED PROPERTY OWNERS. A REVISED PLAN SHOWING OFF-SITE IMPACTS SHOULD BE SUBMITTED AND APPROVED
- PRIOR TO ANY OFF-SITE GRADING. CONTACT PROJECT ENGINEER AND PROJECT EROSION CONTROL INSPECTOR TO ENSURE ADDITIONAL EROSION CONTROL MEASURES ARE INSTALLED PRIOR TO OFF-SITE GRADING. 9. PRIOR TO COMMENCING LAND DISTURBING ACTIVITIES IN AREAS OTHER THAN INDICATED ON THESE PLANS (INCLUDING, BUT NOT LIMITED TO OFF-SITE
- BORROW OR WASTE AREAS, STAGING OR STORAGE AREAS), THE CONTRACTOR SHALL PREPARE AND SUBMIT A SUPPLEMENTARY EROSION CONTROL PLAN TO THE OWNER FOR REVIEW AND TO NCDENR & CITY OF WILMINGTON FOR APPROVAL CONTRACTOR SHALL PAY ALL FEES REQUIRED AND SHALL INSTALL 10. EROSION AND SEDIMENT CONTROL MEASURES SHALL BE MAINTAINED CONTINUOUSLY, RELOCATED WHEN AND AS NECESSARY, AND SHALL BE CHECKED AFTER EVERY RAINFALL. SEEDED AREAS SHALL BE CHECKED REGULARLY AND SHALL BE WATERED, FERTILIZED, RE-EEDED AND MULCHED AS NECESSARY TO OBTAIN A DENSE STAND OF GRASS.
- STABILIZATION IS THE BEST FORM OF EROSION CONTROL. ALL DISTURBED AREAS WHICH ARE NOT OTHERWISE STABILIZED SHALL BE TOP SOILED AND SEEDED, TEMPORARILY OR PERMANENTLY IN ACCORDANCE WITH THE NCDENR & CITY OF WILMINGTON SEDIMENT CONTROL REGULATIONS. PERMANENT SEEDING AND GRASS ESTABLISHMENT IS REQUIRED PRIOR TO PROJECT COMPLETION AND ACCEPTANCE.
- 12. WHEN A CRUSHED STONE CONSTRUCTION ENTRANCE HAS BEEN COVERED WITH SOIL OR HAS BEEN PUSHED INTO THE SOIL BY CONSTRUCTION TRAFFIC, IT SHALL BE REPLACED WITH A DEPTH OF STONE EQUAL TO THAT OF THE ORIGINAL APPLICATION.
- 13. TEMPORARY GRAVEL CONSTRUCTION ENTRANCE SHALL BE REQUIRED AT ALL CONSTRUCTION STAGING AREA ENTRANCES AND ALL CONSTRUCTION ACCESS LOCATIONS INTO NON-PAVED AREA. SIX INCHES OF STONE SHALL BE USED FOR THE TEMPORARY GRAVEL CONSTRUCTION ENTRANCE.
- 14. ALL DRAINAGE INLETS SHALL BE PROTECTED FROM SILTATION. INEFFECTIVE PROTECTION DEVICES SHALL BE IMMEDIATELY REPLACED AND THE INLET CLEANED. FLUSHING IS NOT AN ACCEPTABLE METHOD OF CLEANING.
- 15. SEDIMENT BASINS AND TRAPS, PERIMETER DIKES, SEDIMENT BARRIERS AND OTHER MEASURES INTENDED TO TRAP SEDIMENT SHALL BE CONSTRUCTED AS A FIRST STEP IN ANY LAND-DISTURBING ACTIVITY AND SHALL BE MADE FUNCTIONAL BEFORE UP-SLOPE LAND DISTURBANCE TAKES PLACE.
- 16. ALL DISTURBED AREAS ARE TO DRAIN TO APPROVED SEDIMENT CONTROL MEASURES AT ALL TIMES DURING LAND DISTURBING ACTIVITIES AND DURING SITE DEVELOPMENT UNTIL FINAL STABILIZATION IS COMPLETED. 17. DURING DE-WATERING OPERATIONS, WATER SHALL BE PUMPED INTO AN APPROVED FILTERING DEVICE PRIOR TO DISCHARGE TO RECEIVING OUTLET.
- 18. THE CONTRACTOR SHALL INSPECT ALL EROSION CONTROL MEASURES PERIODICALLY AND AFTER EACH RUNOFF-PRODUCING EVENT. ANY NECESSARY REPAIRS OR CLEANUP TO MAINTAIN THE EFFECTMENESS OF THE EROSION CONTROL DEVICES SHALL BE MADE IMMEDIATELY.

#### <u> CONSTRUCTION SEQUENCE:</u>

\_\_\_\_\_) 48 HOURS BEFORE ANY LAND DISTURBANCE OCCURS.

- 2. CONTRACTOR SHALL ENSURE THAT ALL NECESSARY PERMITS HAVE BEEN RECEIVED AND THAT THOSE REQUIRED TO BE DISPLAYED ON-SITE ARE AVAILABLE. 3. CONTRACTOR SHALL HOLD A PRE-CONSTRUCTION MEETING AT LEAST 48 HOURS BEFORE THE ACTUAL START OF CONSTRUCTION. CONTACT CITY INSPECTOR
- 4. CONTRACTOR SHALL CONTACT CARCLINA ONE CALL AND ALL ENTITIES HAVING BURIED UTILITIES AT LEAST 72 HOURS PRIOR TO DIGGING OR AS DIRECTED AT THE PRE—CONSTRUCTION MEETING.
- 5. CONTRACTOR SHALL INSTALL TEMPORARY CONSTRUCTION ENTRANCES AT EACH POINT OF ACCESS TO STORAGE AND CONSTRUCTION AREAS. 6. INITIAL PHASE SEDIMENT AND EROSION CONTROL MEASURES SHALL BE INSTALLED IN ACCORDANCE WITH PLANS BEFORE STARTING WORK INCLUDING SIL
- FENCE, INLET PROTECTION, DMERSION DITCHES, TREE PROTECTION, ETC., CLEARING ONLY AS NECESSARY FOR THE INSTALLATION OF THESE MEASURES. CONTRACTOR SHALL INCLUDE A RAIN GAUGE AND LOG BOOK CONTAINING THE INSPECTION RECORDS FOR THE SITE ALL DEMOLITION DEBRIS IS TO GO TO AN APPROVED LANDFILL OR PERMITTED FACILIT
- CONTRACTOR TO USE PARKING AREAS ADJACENT TO THE PROPOSED BUILDING FOR LAY-DOWN/STAGING AREAS MAINTAIN THESE AREAS SO THAT SEDIMENT LADEN RUNOFF WILL BE DIVERTED TO EROSION CONTROL MEASURES. INSTALL SILT FENCE AROUND STOCKPILE AREA AS SHOWN 7. CONTRACTOR SHALL DILIGENTLY AND CONTINUOUSLY MAINTAIN ALL EROSION CONTROL DEVICES AND STRUCTURES.
- ALL APPLICABLE E&S CONTROL MEASURES MUST BE MAINTAINED UNTIL PERMANENT VEGETATION IS ESTABLISHED.
- 8. STOCKPILE RIP-RAP ON SITE AND INSTALL ALL EROSION CONTROL MEASURES WHERE THE WORK IS OCCURRING. ADDITIONAL EROSION CONTROL MEASURES MAY BE REQUIRED BY THE ENGINEER OR UPON RECOMMENDATION OF INSPECTION PERSONNEL AS CONDITIONS WARRANT.
- 9. ALL DISTURBED AREAS SHALL HAVE GROUND STABILIZATION BY THE CONTRACTOR ACCORDING TO THE CHART ON THIS SHEET.
- UPON COMPLETION OF THE INSTALLATION AND WITH APPROVAL OF CITY OF WILMINGTON, ALL EROSION CONTROL DEVICES SHALL BE REMOVED AND
  DISPOSED OF IN AN ACCEPTABLE MANNER. EACH SECTION SHALL BE SEEDED AT EARLIEST POSSIBLE DATE AFTER INSTALLATION OF PIPE, STRUCTURE, OR
  ACCESS. COORDINATE WITH THE EROSION CONTROL INSPECTOR PRIOR TO REMOVAL OF EROSION CONTROL MEASURES.
- 12. ONCE GROUND COVER IS FIRMLY ESTABLISHED, ALL TEMPORARY EROSION CONTROL MEASURES SHALL BE REMOVED WITH THE APPROVAL OF INSPECTOR.

S	TABILIZATION 7	<b>FIMEFRAME</b>
SITE AREA DESCRIPTION	STABILIZATION	TIMEFRAME EXCEPTIONS
PERIMETER DIKES, SWALES, DITCHES AND SLOPES	7 DAYS	NONE
SLOPES STEEPER THAN 3:1	7 DAYS	IF SLOPES ARE 10' OR LESS IN LENGTH AND ARE NOT STEEPER THAN 2:1, 14 DA. ARE ALLOWED
SLOPES 3:1 OR FLATTER	14 DAYS	7 DAYS FOR SLOPES GREATER THAN 50FT IN LENGTH
ALL OTHER AREAS WITH SLOPES FLATTER THAN 4:1	14 DAYS	NONE, EXCEPT FOR PERIMETERS AND HQW ZONES

GROUND COVER REQUIREMENTS:


THE ANGLE FOR GRADED SLOPES AND FILLS SHALL BE NO GREATER THAN THE ANGLE THAT CAN BE RETAINED BY VEGETATIVE COVER OR OTHER ADEQUATE EROSION—CONTROL DEVICES OR STRUCTURES. IN ANY EVENT, SLOPES LEFT EXPOSED WILL, ACCORDING TO THE FOLLOWING CHART, BE PLANTED OR OTHERWISE PROVIDED WITH TEMPORARY OR PERMANENT GROUND COVER, DEVICES, OR STRUCTURES SUFFICIENT TO RESTRAIN EROSION. PROVISIONS FOR PERMANENT GROUNDCOVER SUFFICIENT TO RETAIN EROSION MUST BE ACCOMPLISHED FOR ALL DISTURBED AREAS ACCORDING TO THE FOLLOWING CHART OLLOWING COMPLETION OF CONSTRUCTION OR DEVELOPMENT.

#### NOTE TO CONTRACTOR:

THE CONTRACTOR SHALL NOTIFY THE PROJECT ENGINEER AND THE EROSION CONTROL INSPECTOR OF THE LOCATION OF ANY OFF-SITE BORROW SOURCE OR OFF-SITE WASTE MATERIAL DISPOSAL SITE. OFF-SITE DISTURBANCES COUNT TOWARDS THE OVERALL PROJECT DISTURBED AREA AND MUST BE COVERED BY THE PERMIT FOR THIS PROJECT AND/OR THE PERMIT FROM ANOTHER ACTIVE CITY OF WILMINGTON OR NCDENR PERMITTE SITE THAT IS APPROPRIATE FOR THE INTENDED USE (I.E. APPLICABLE MINING REQUIREMENTS). NO OFF—SITE ACTIVITIES SHALL OCCUR UNTIL THE PERMIT FOR THIS PROJECT HAS BEEN MODIFIED TO INCLUDE THE AFFECTED AREAS OR IT HAS BEEN VERIFIED WITH THE EROSION CONTROL INSPECTOR THAT THE OFF-SITE AREAS ARE COVERED UNDER ACTIVE APPLICABLE CITY OF WILMINGTON OR NCDENR PERMITS.

**EROSION CONTROL NOTES:** 


REFER TO SHEET C1.4 FOR TEMPORARY AND PERMANENT SEEDING SCHEDULES FOR PROVIDING GROUND COVER THE FOR THE DEVELOPMENT.

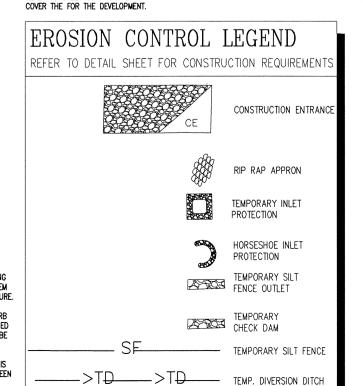

THE PROPOSED EROSION AND SEDIMENT CONTROL MEASURES ARE INTENDED TO TRAP ANY STORMWATER RUNOFF FROM THE CONSTRUCTION SITE AND DETAIN IT LONG ENOUGH FOR SEDIMENT AND POLLUTANTS TO SETTLE OUT OF THE STORMWATER BEFORE DISCHARGE. VARIOUS EROSION CONTROL MEASURES ARE USED TO PREVENT POLLUTANT—LADEN STORMWATER RUNOFF FROM FLOWING ONTO ADJACENT PROPERTIES.



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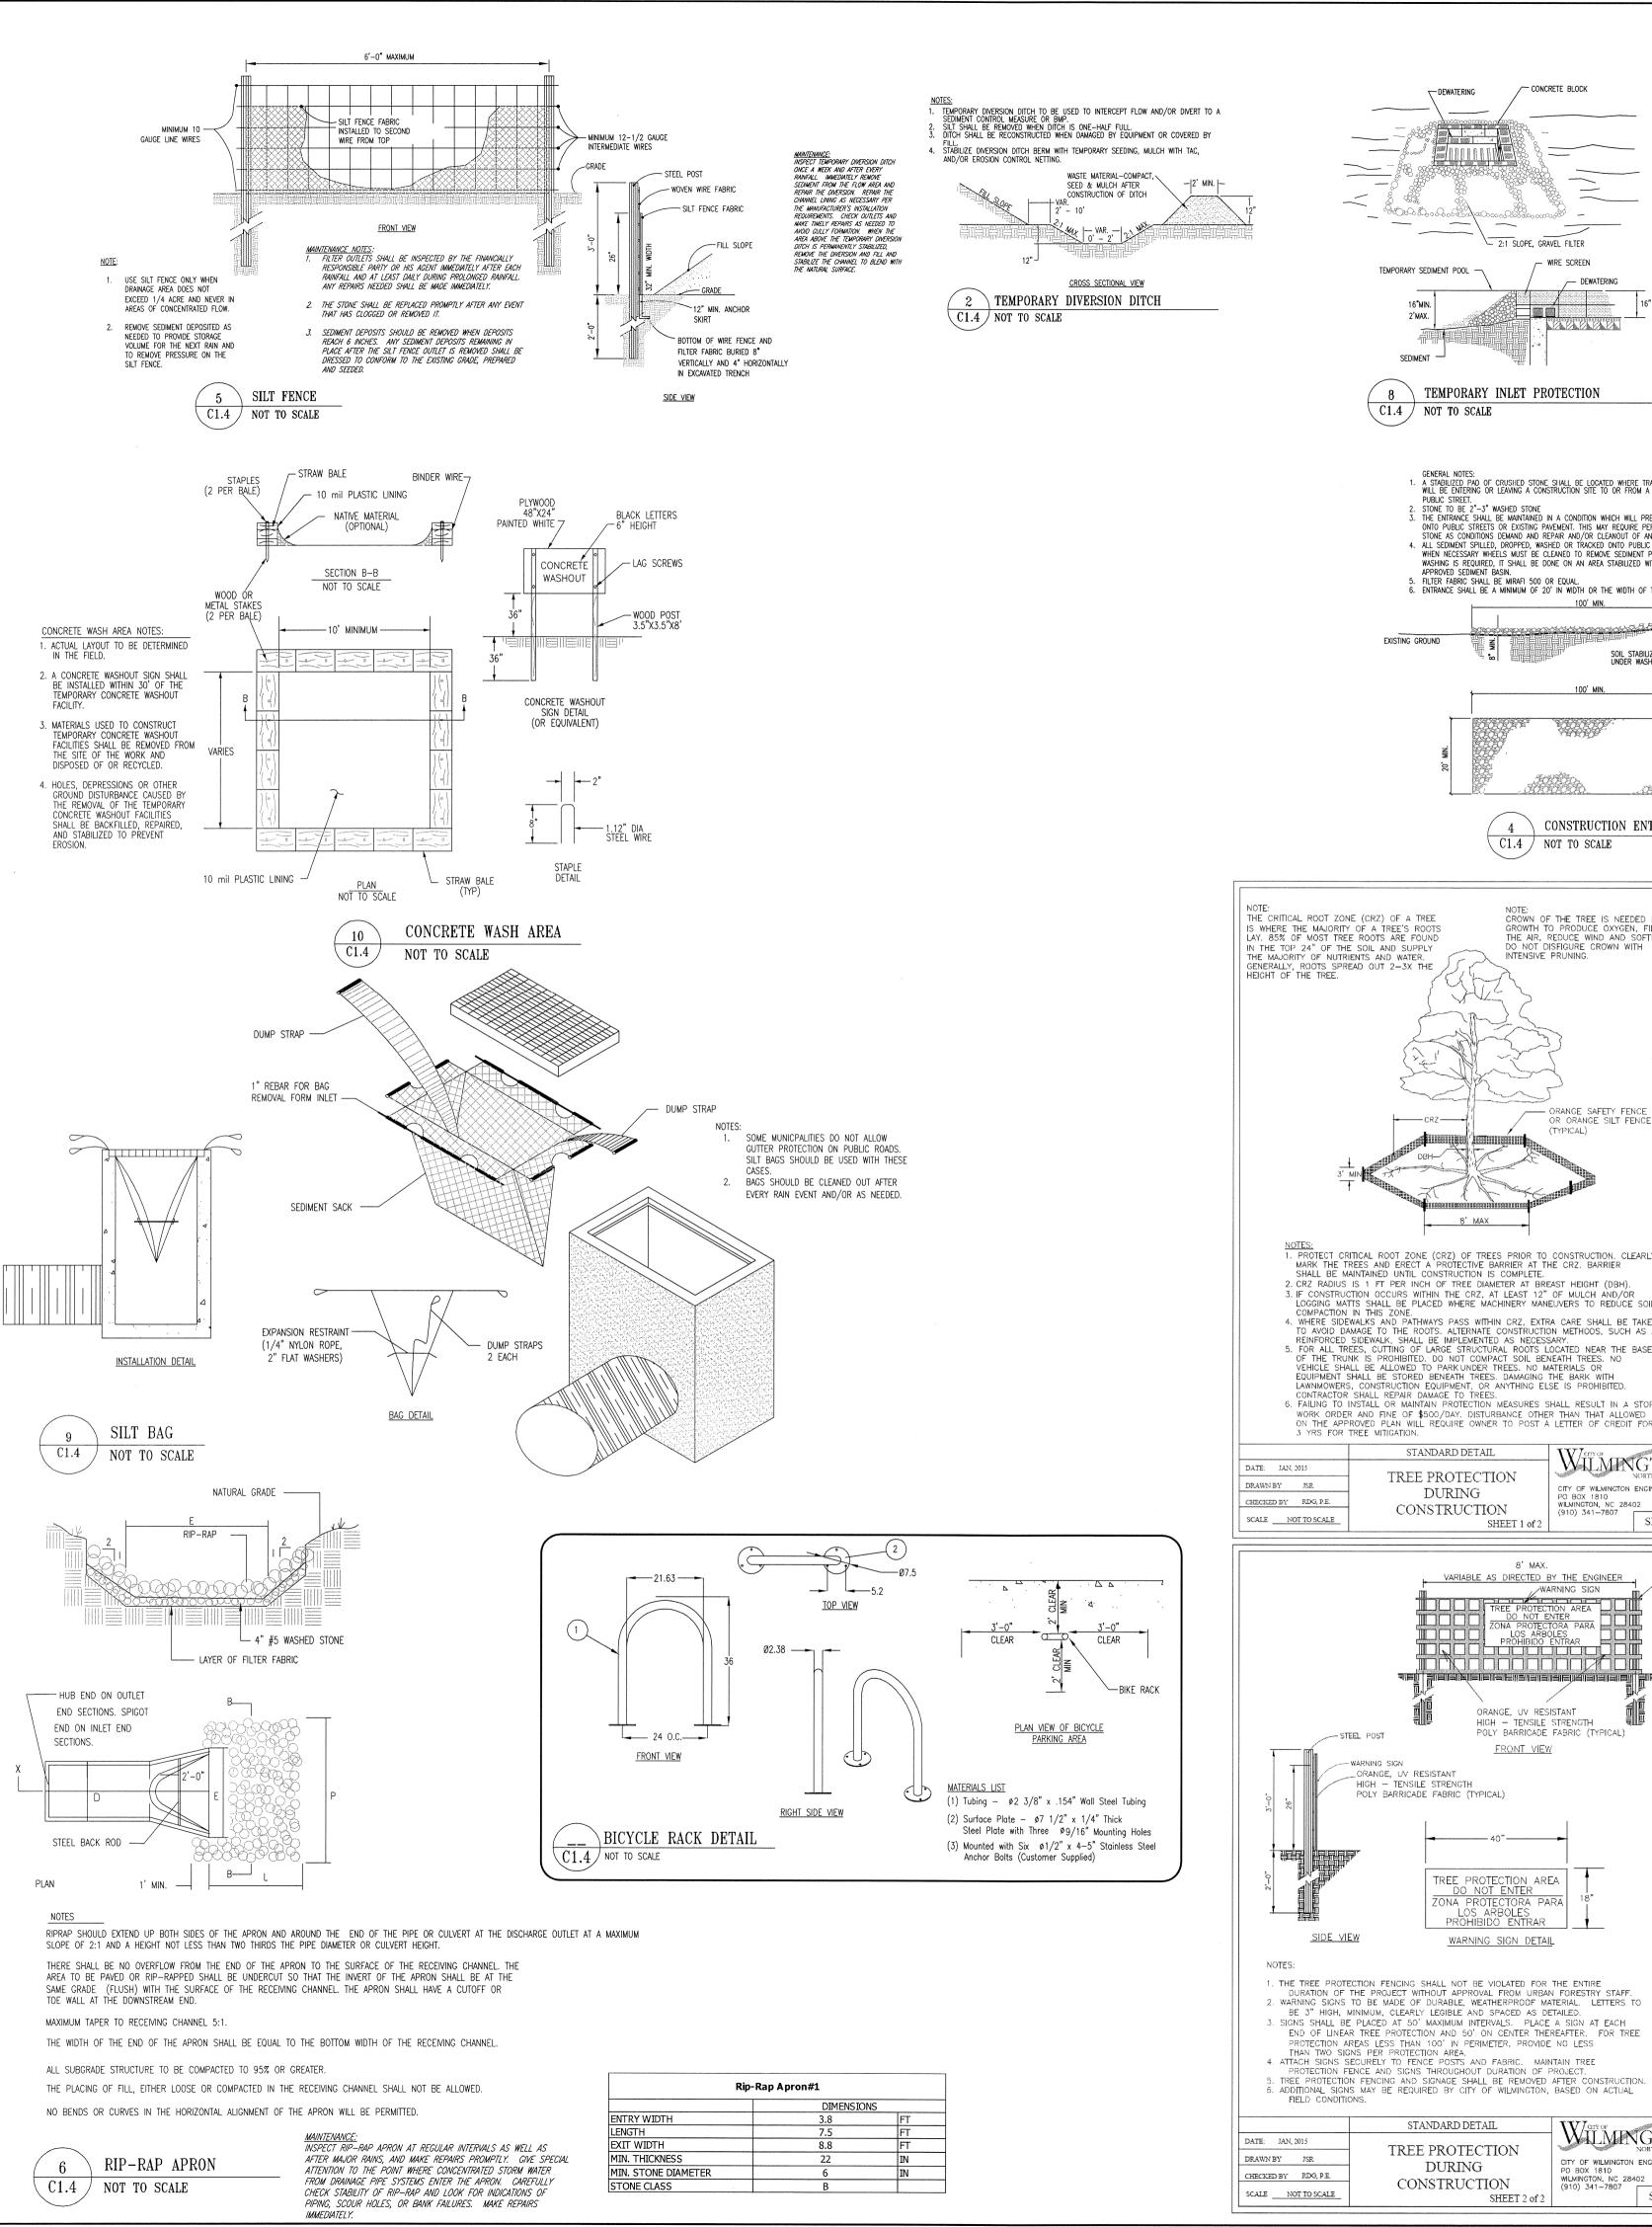
OWNER/DEVELOPER: AUTOZONE DEVELOPMENT, LLC ATTN. WADE DAVIS 123 S. FRONT STREET 3RD FLOOR MEMPHIS, TN 38103-2107 PHONE: (901) 495-8701 FAX: (901) 495-8969 wade.davis@autozone.com For Bidding & Contractor Information Contact: F.W. Dodge Plan Room Tel: (615) 884-1017

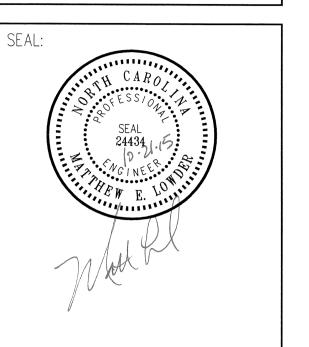
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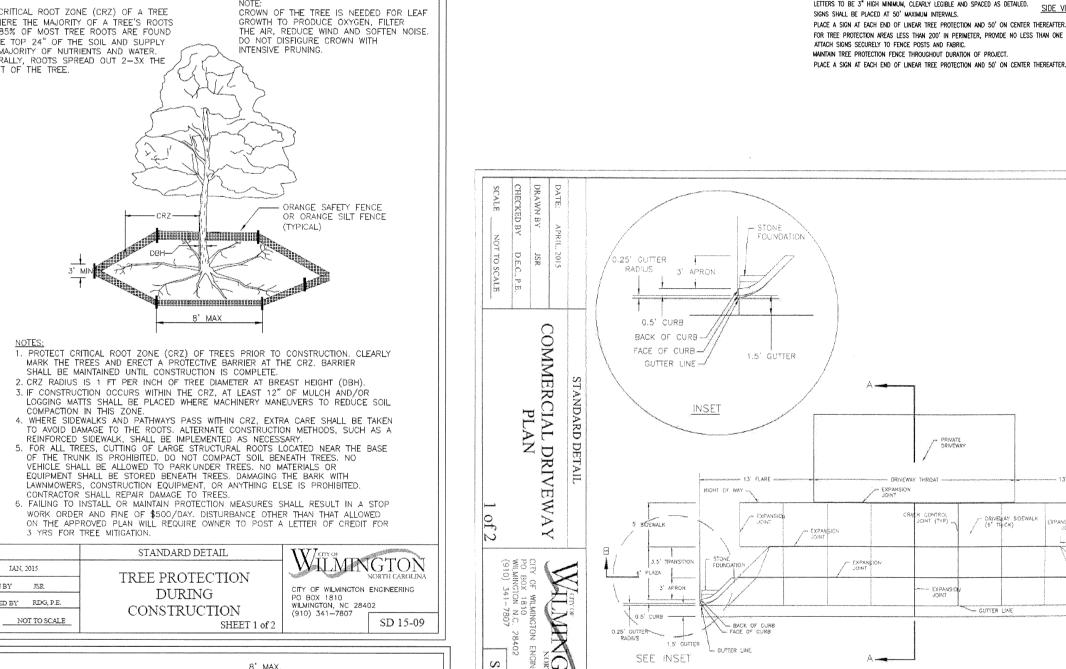
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COMMENTS:

SHEET NUMBER:






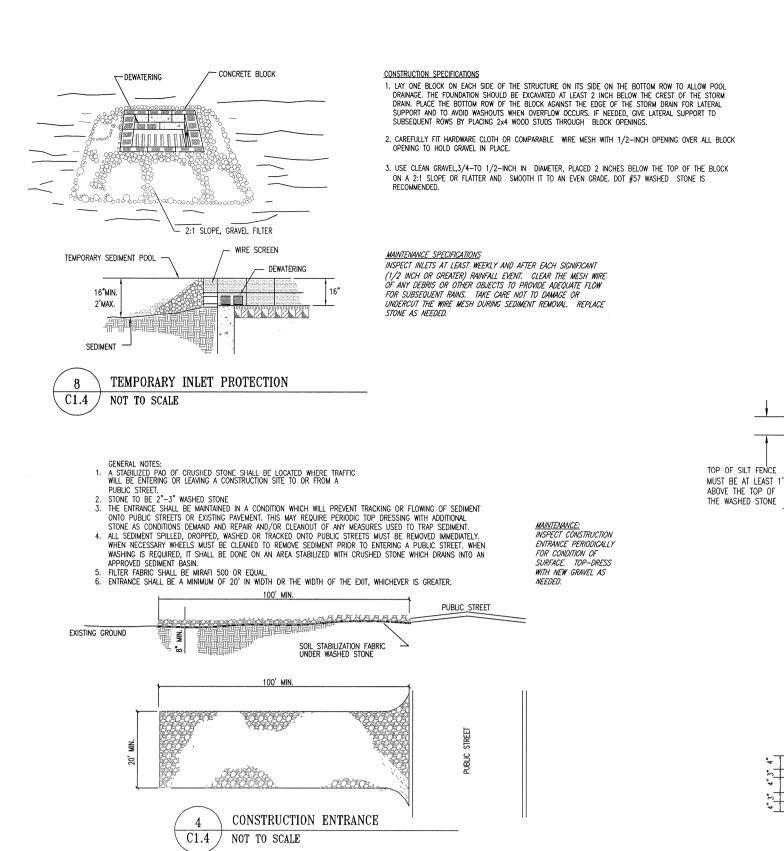



ORANGE, UV RESISTANT


FRONT VIEW

HIGH — TENSILE STRENGTH TO POLY BARRICADE FABRIC (TYPICAL)

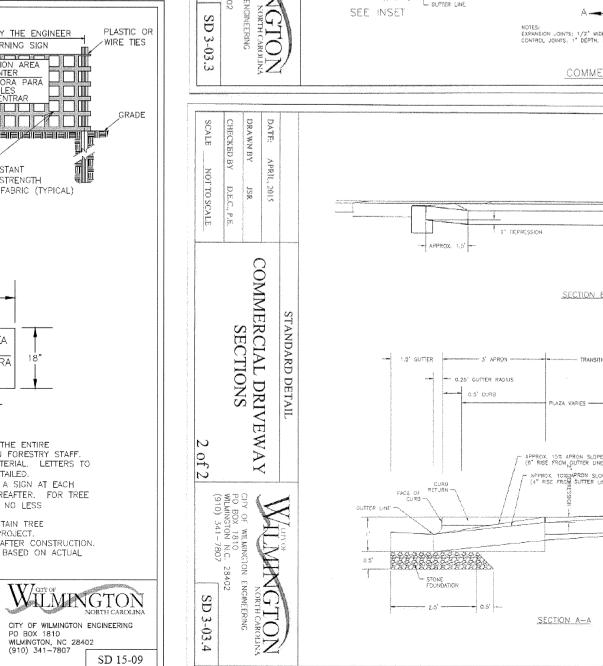

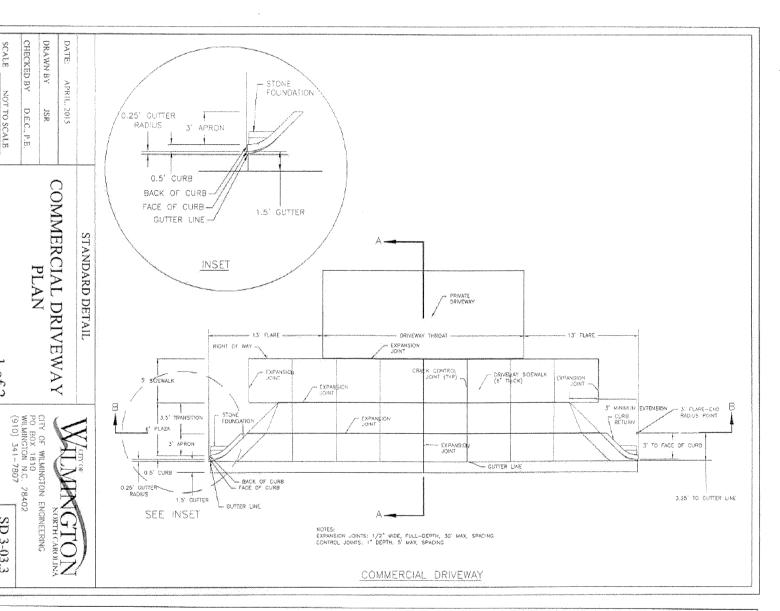

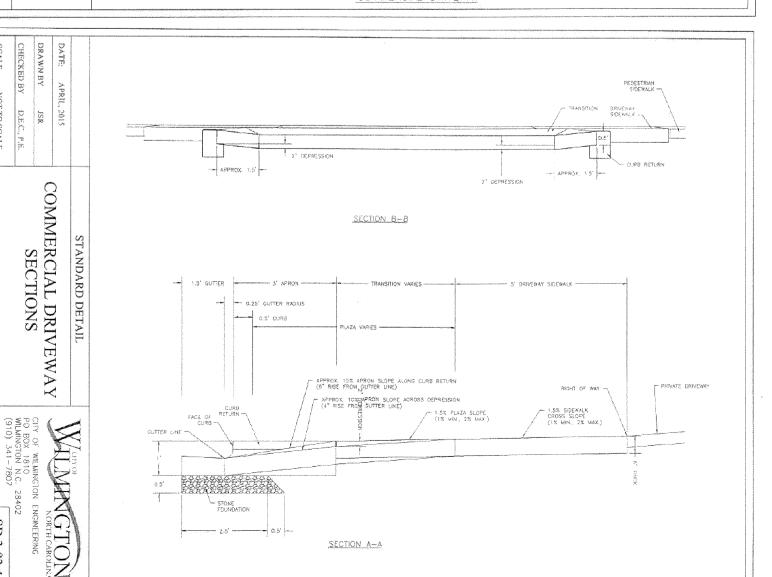

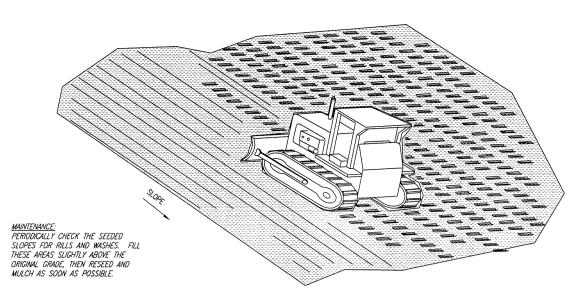


SLOPE TRACKING DETAIL USE DOZER TRACKS TO CREATE GROOVES
PERPENDICULAR TO THE SLOPE. GROOVES WILL CATCH
SEED, FERTILIZER, MULCH, RAINFALL AND DECREASE NOT TO SCALE

STEEL FENCE POST WIRE FENCE \ WHEN HALF OF STONE OUTLET IS COVERED. REPLACE STONE AS NEEDED TO ENSURE HARDWARE CLOTH < FILTER OF #57 / WASHED STONE 3' FILTER FABRIC o /ON GROUND BOTTOM OF WIRE FENCE AND BURY WIRE FENCE AND HARDWARE CLOTH FRONT VIEW VERTICALLY AND 4" HORIZONTALLY IN EXCAVATED TRENCH SECTION VIEW SET MAX 2' APART MANIFAMNE NOTES:

RILER OUTLITS SHALL BE INSPECTED BY THE FINANCIALLY RESPONSIBLE PARTY OR HIS AGENT IMMEDIATELY ATTER EACH PANIFALL AND AT LEAST DALLY DURING PROLONGED PANIFALL, ANY REPAIRS NEEDED SHALL BE MADI AND HARDWARE MIN. 18" INTO

2. THE STONE SHALL BE REPLACED PROMPTLY AFTER ANY EVENT THAT HAS CLOGGED OR REMOVED IT. 3. SEDIMENT DEPOSITS SHOULD BE REMOVED WHEN DEPOSITS REACH HALF THE HEIGHT OF THE BARRIER. ANY SEDIMENT DEPOSITS REMAINING IN PLACE AFTER THE SILT FENCE OUTLET IS REMOVED SHALL BE DRESSED TO CONFORM TO THE EXISTING GRADE, PREPARED AND SEEDED. SILT FENCE OUTLET C1.4 NOT TO SCALE

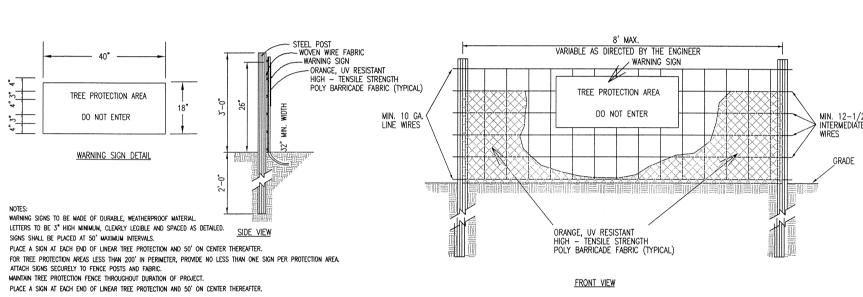

6 TREE PROTECTION FENCE C1.4 NOT TO SCALE

#### SEEDBED PREPARATION:

SUPERPHOSPHATE

- 1. CHISEL COMPACTED AREAS AND SPREAD TOPSOIL THREE INCHES DEEP OVER ADVERSE SOIL CONDITIONS, IF AVAILABLE. 2. RIP THE ENTIRE AREA TO SIX INCHES DEEP.
- 3. REMOVE ALL LOOSE ROCK, ROOTS AND OTHER OBSTRUCTIONS, LEAVING SURFACE REASONABLY SMOOTH AND UNIFORM. 4. APPLY AGRICULTURAL LIME, FERTILIZER, AND SUPERPHOSPHATE UNIFORMLY AND MIX WITH SOIL (SEE SEEDING MIXTURE). CONTINUE TILLAGE UNITL A WELL-PULVERIZED, FIRM, REASONABLY UNIFORM SEEDBED IS PREPARED FOUR TO SIX
- 6. SEED ON A FRESHLY PREPARED SEEDBED AND COVER SEED LIGHTLY WITH SEEDING EQUIPMENT OR CULTIPACK AFTER
- . MULCH IMMEDIATELY AFTER SEEDING AND ANCHOR MULCH.
- 8. INSPECT ALL SEEDED AREAS AND MAKE NECESSARY REPAIRS OR RESEEDINGS WITHIN THE PLANTING SEASON, IF POSSIBLE. IF STAND SHOULD BE MORE THAN 60% DAMAGED, RE-ESTABLISH FOLLOWING THE ORIGINAL LIME, FERTILIZER AND SEEDING RATES.
- CONSULT S&EC ENVIRONMENTAL ENGINEERS ON MAINTENANCE TREATMENT AND FERTILIZATION AFTER PERMANENT COVER IS ESTABLISHED.

2 TONS/ACRE - SMALL GRAIN STRAW

ASPHALT EMULSION AT 400 GALS/ACRE

35 lbs/acre Browntop Millet

30 lbs/acre Sorghum-Sudan Hybrids

SEEDING MIXTURE: 2 TONS/ACRE (3 TONS/ACRE IN CLAY SOILS) AGRICULTURE LIMESTONE 1,000 LBS/ACRE - 10-10-10 500 LBS/ACRE - 20% ANALYSIS

TEMPORARY SEEDING SPECIFICATIONS/SCHEDULE Planting Rate

Browntop Millet 40 lbs/acre 120 lbs/acre

SEEDING SPECIFICATIONS/SCHEDULE

FOR SHOULDERS, SIDE DITCHES, SLOPES (MAX 3:1) Date Туре Planting Rate Aug 15 - Nov 1 Tall Fescue 300 lbs/acre Nov 1 - Mar 1 Tall Fescue & Abruzzi Rye 300 lbs/acre Mar 1 - Apr 15 Tall Fescue 300 lbs/acre Apr 14 - Jun 30 Hulled Common Bermuda Grass 25 lbs/acre Jul 1 - Aug 15 Tall Fescue & Browntop Millet 240 lbs/acre-Tall Fescue;


FOR SHOULDERS, SIDE DITCHES, SLOPES (3:1 - 2:1) Туре

or Sorghum-Sudan Hybrids

Planting Rate Mar 1 - Jun 1 Sericea Lespedeza (scarified) & 50 lbs/acre (Serica Lespedeza) use the following combinations: Mar 1 - Apr 15 Add Tall Fescue 240 lbs/acre Mar 1 - Jun 30 Or add Julled Common 25 lbs/acre Bermuda Grass Jun 1 - Sep 1 Tall Fescue & Browntop Millet 240 lbs/acre Tall Fescue 35 lbs/acre Browntop Millet


or Sorghum-Sudan Hybrids 30 lbs/acre Sorghum-Sudan 70 lbs/acre Sericea Lespedeza Sericea Lespedeza (Unhulled-240 lbs/acre Tall Fescue Unscarafied & Tall Fescue Nov 1 – Mar 1 Add Abruzzi Rye 25 lbs/acre

CONSULT S&EC ENGINEER FOR ADDITIONAL INFORMATION CONCERNING OTHER ALTERNATIVES FOR VEGETATION OF DENUDED AREAS. THE ABOVE VEGETATION RATES ARE THOSE THAT DO WELL UNDER LOCAL CONDITIONS; OTHER SEEDING RATE COMBINATIONS ARE POSSIBLE. \*\*\* TEMPORARY: RESEED ACCORDING TO OPTIMUM SEASON FOR DESIRED PERMANENT VEGETATION. DO NOT ALLOW TEMPORARY COVER TO GROW MORE THAN 12" IN HEIGHT BEFORE MOWING; OTHERWISE, FESCUE MAY BE SHADED OUT.

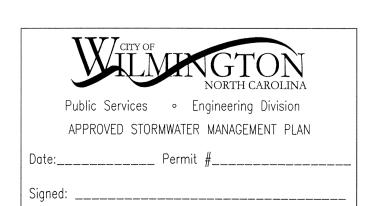



CONSULTANT: TRIANGLE SITE DESIGN, PLLC 4006 BARRETT DR, STE 203 RALEIGH, NC 27609 (919) 553-6570 LICENSE #P-0619

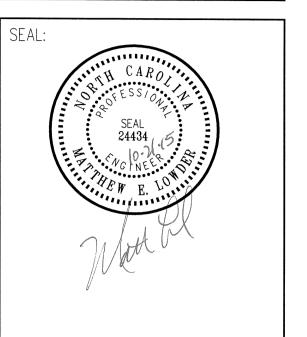

OWNER/DEVELOPER: AUTOZONE DEVELOPMENT, LLC ATTN. WADE DAVIS 123 S. FRONT STREET MEMPHIS, TN 38103-2107

F.W. Dodge Plan Room Tel: (615) 884-1017 REVISIONS: 10/21/15 REVISED PER CITY OF WILMINGTON REVIEW COMMENTS

3RD FLOOR

PHONE: (901) 495-8701

FAX: (901) 495-8969


wade.davis@autozone.com

For Bidding & Contractor Information Contact:

LAYOUT COORD:	ME
PLANNING MGR.	ME
DRAWING BY:	ME
DATE:	SEPTEMBER 29, 201
JOB NUMBER:	01004

TITLE:

SHEET NUMBER:

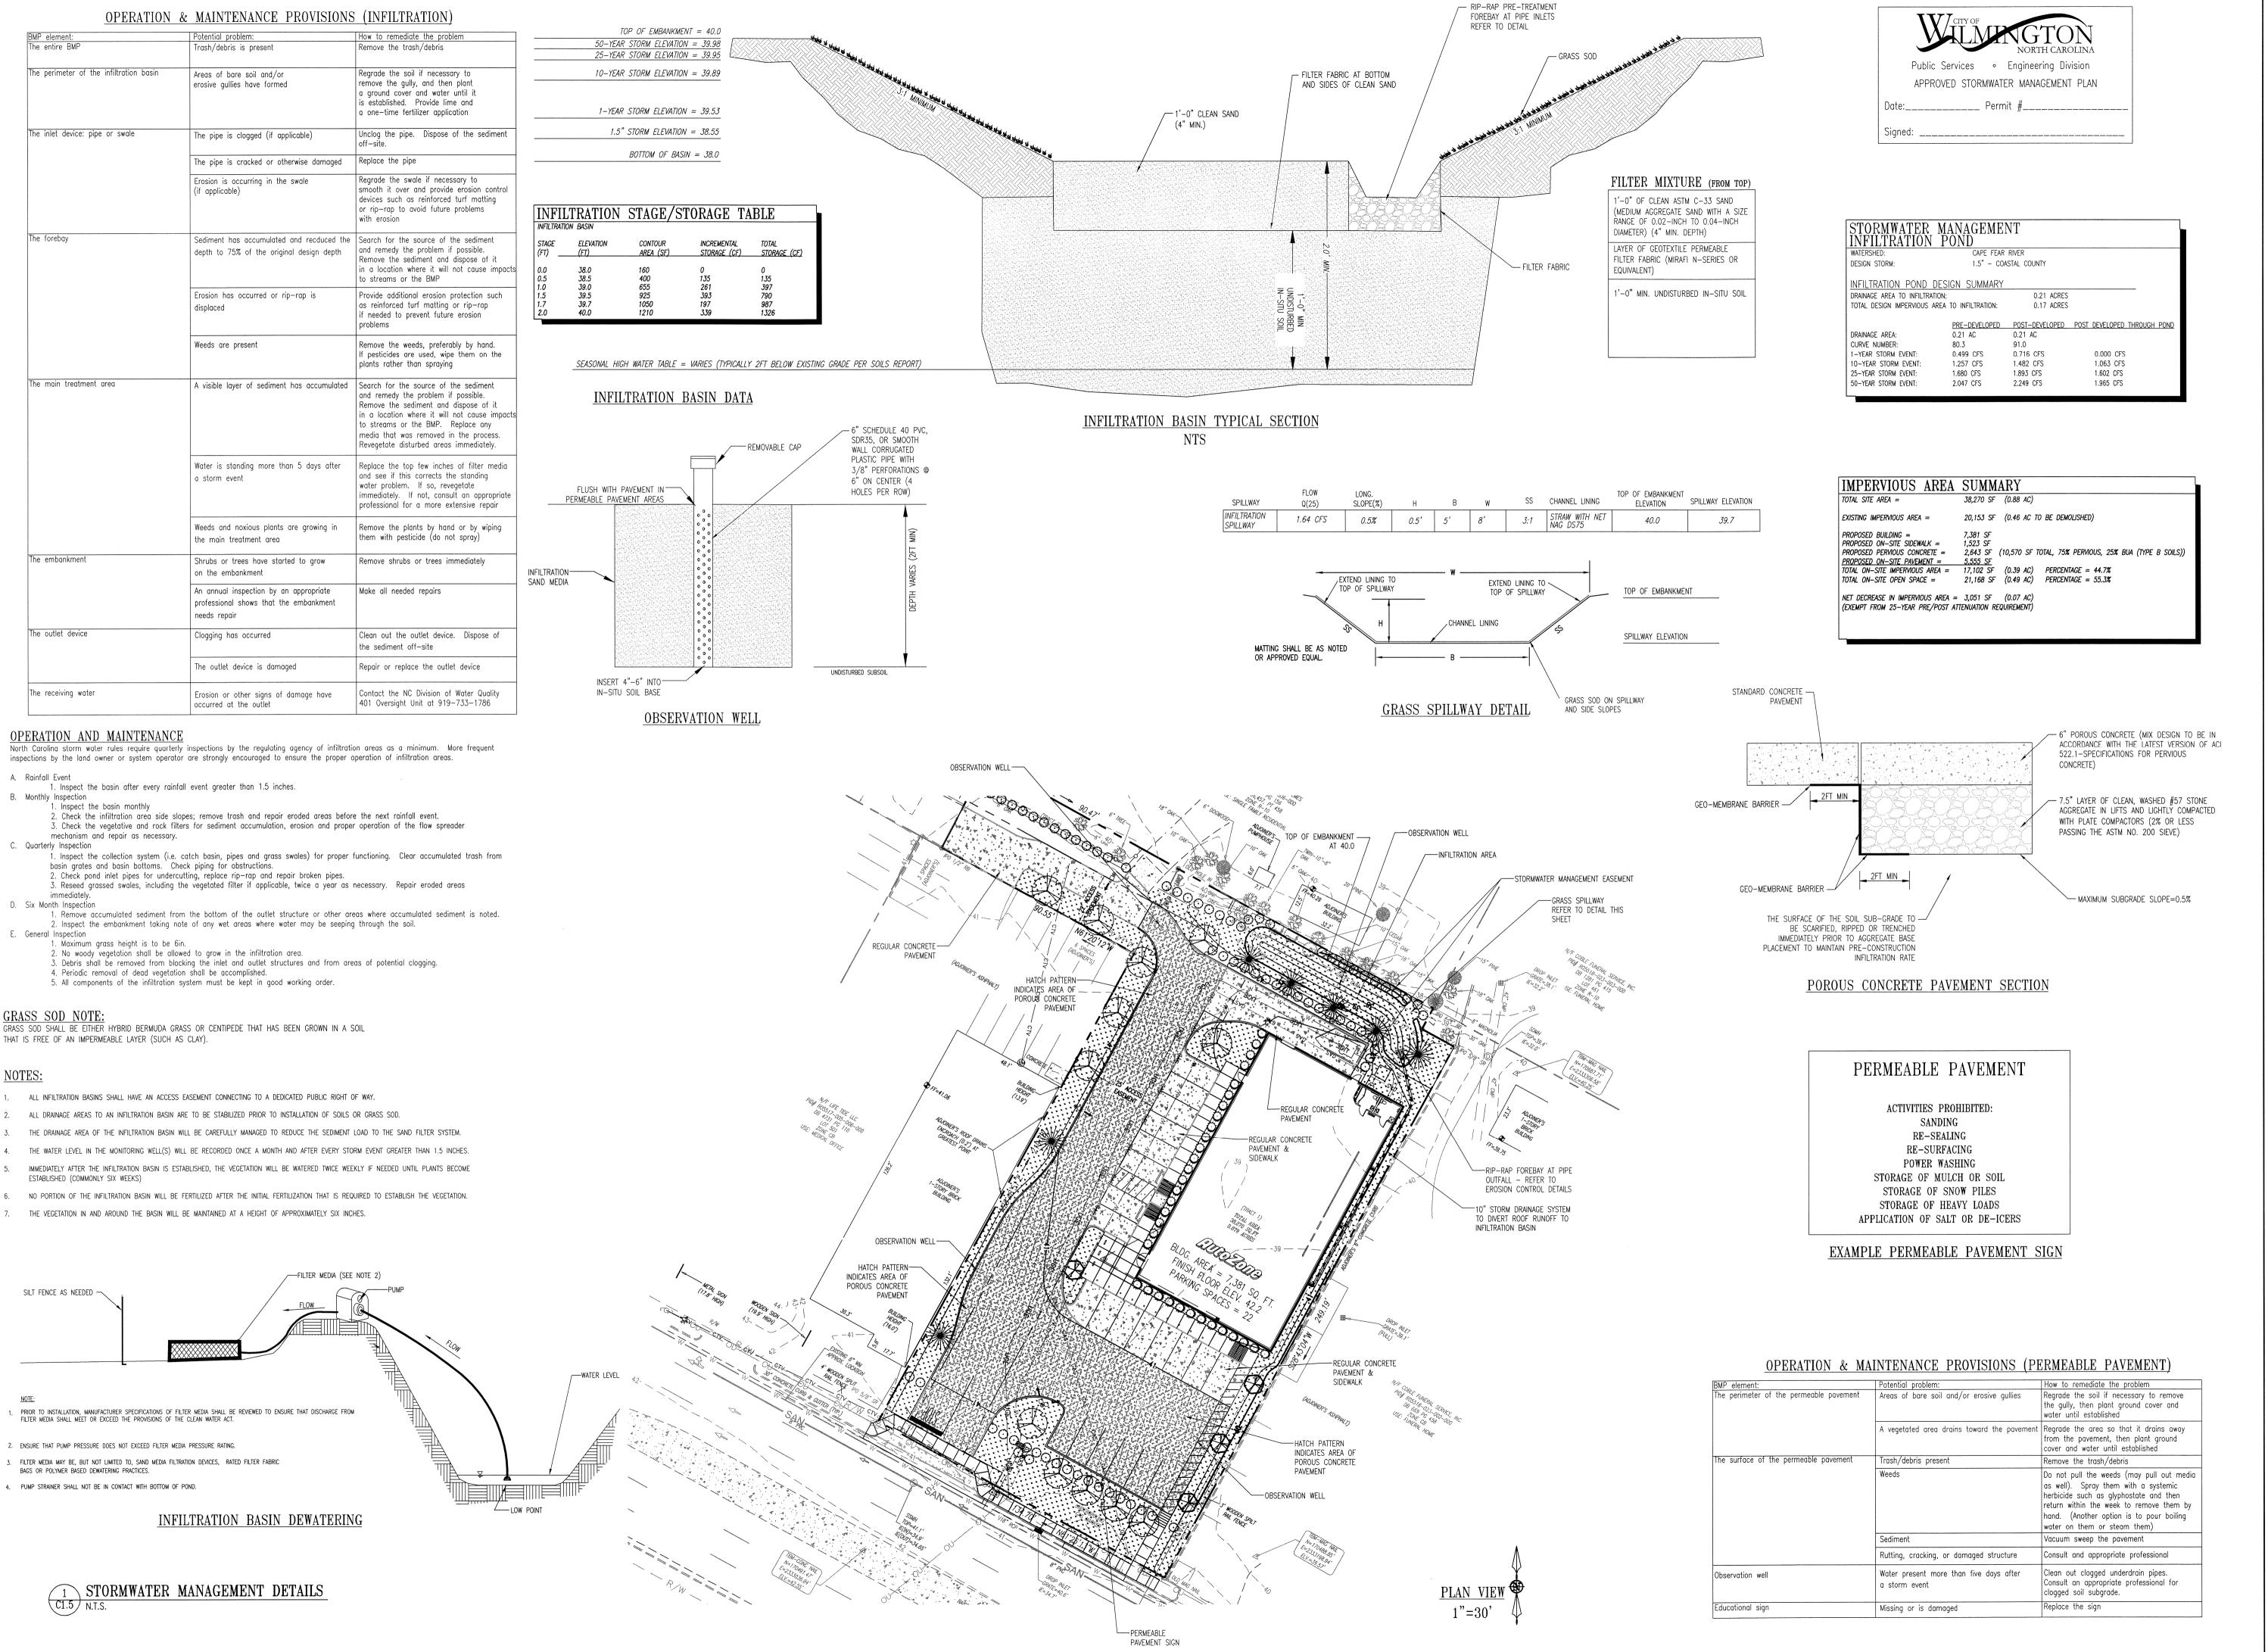



CONSULTANT:
TRIANGLE SITE DESIGN, PLLC
4006 BARRETT DR, STE 203
RALEIGH, NC 27609
(919) 553-6570
LICENSE #P-0619



Moth Records

AutoZone-Oleander Store Number: 6486

OWNER/DEVELOPER:
AUTOZONE DEVELOPMENT, LLC
ATTN. WADE DAVIS
123 S. FRONT STREET
3RD FLOOR
MEMPHIS. TN 38103-2107

MEMPHIS, TN 38103-2107
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PLANNING MGR. MEL

DRAWING BY: MEL


DATE: SEPTEMBER 29, 2015

JOB NUMBER: 010048

STORMWATER MANAGEMENT DETAIL

SHEET NUMBER:

C1.5

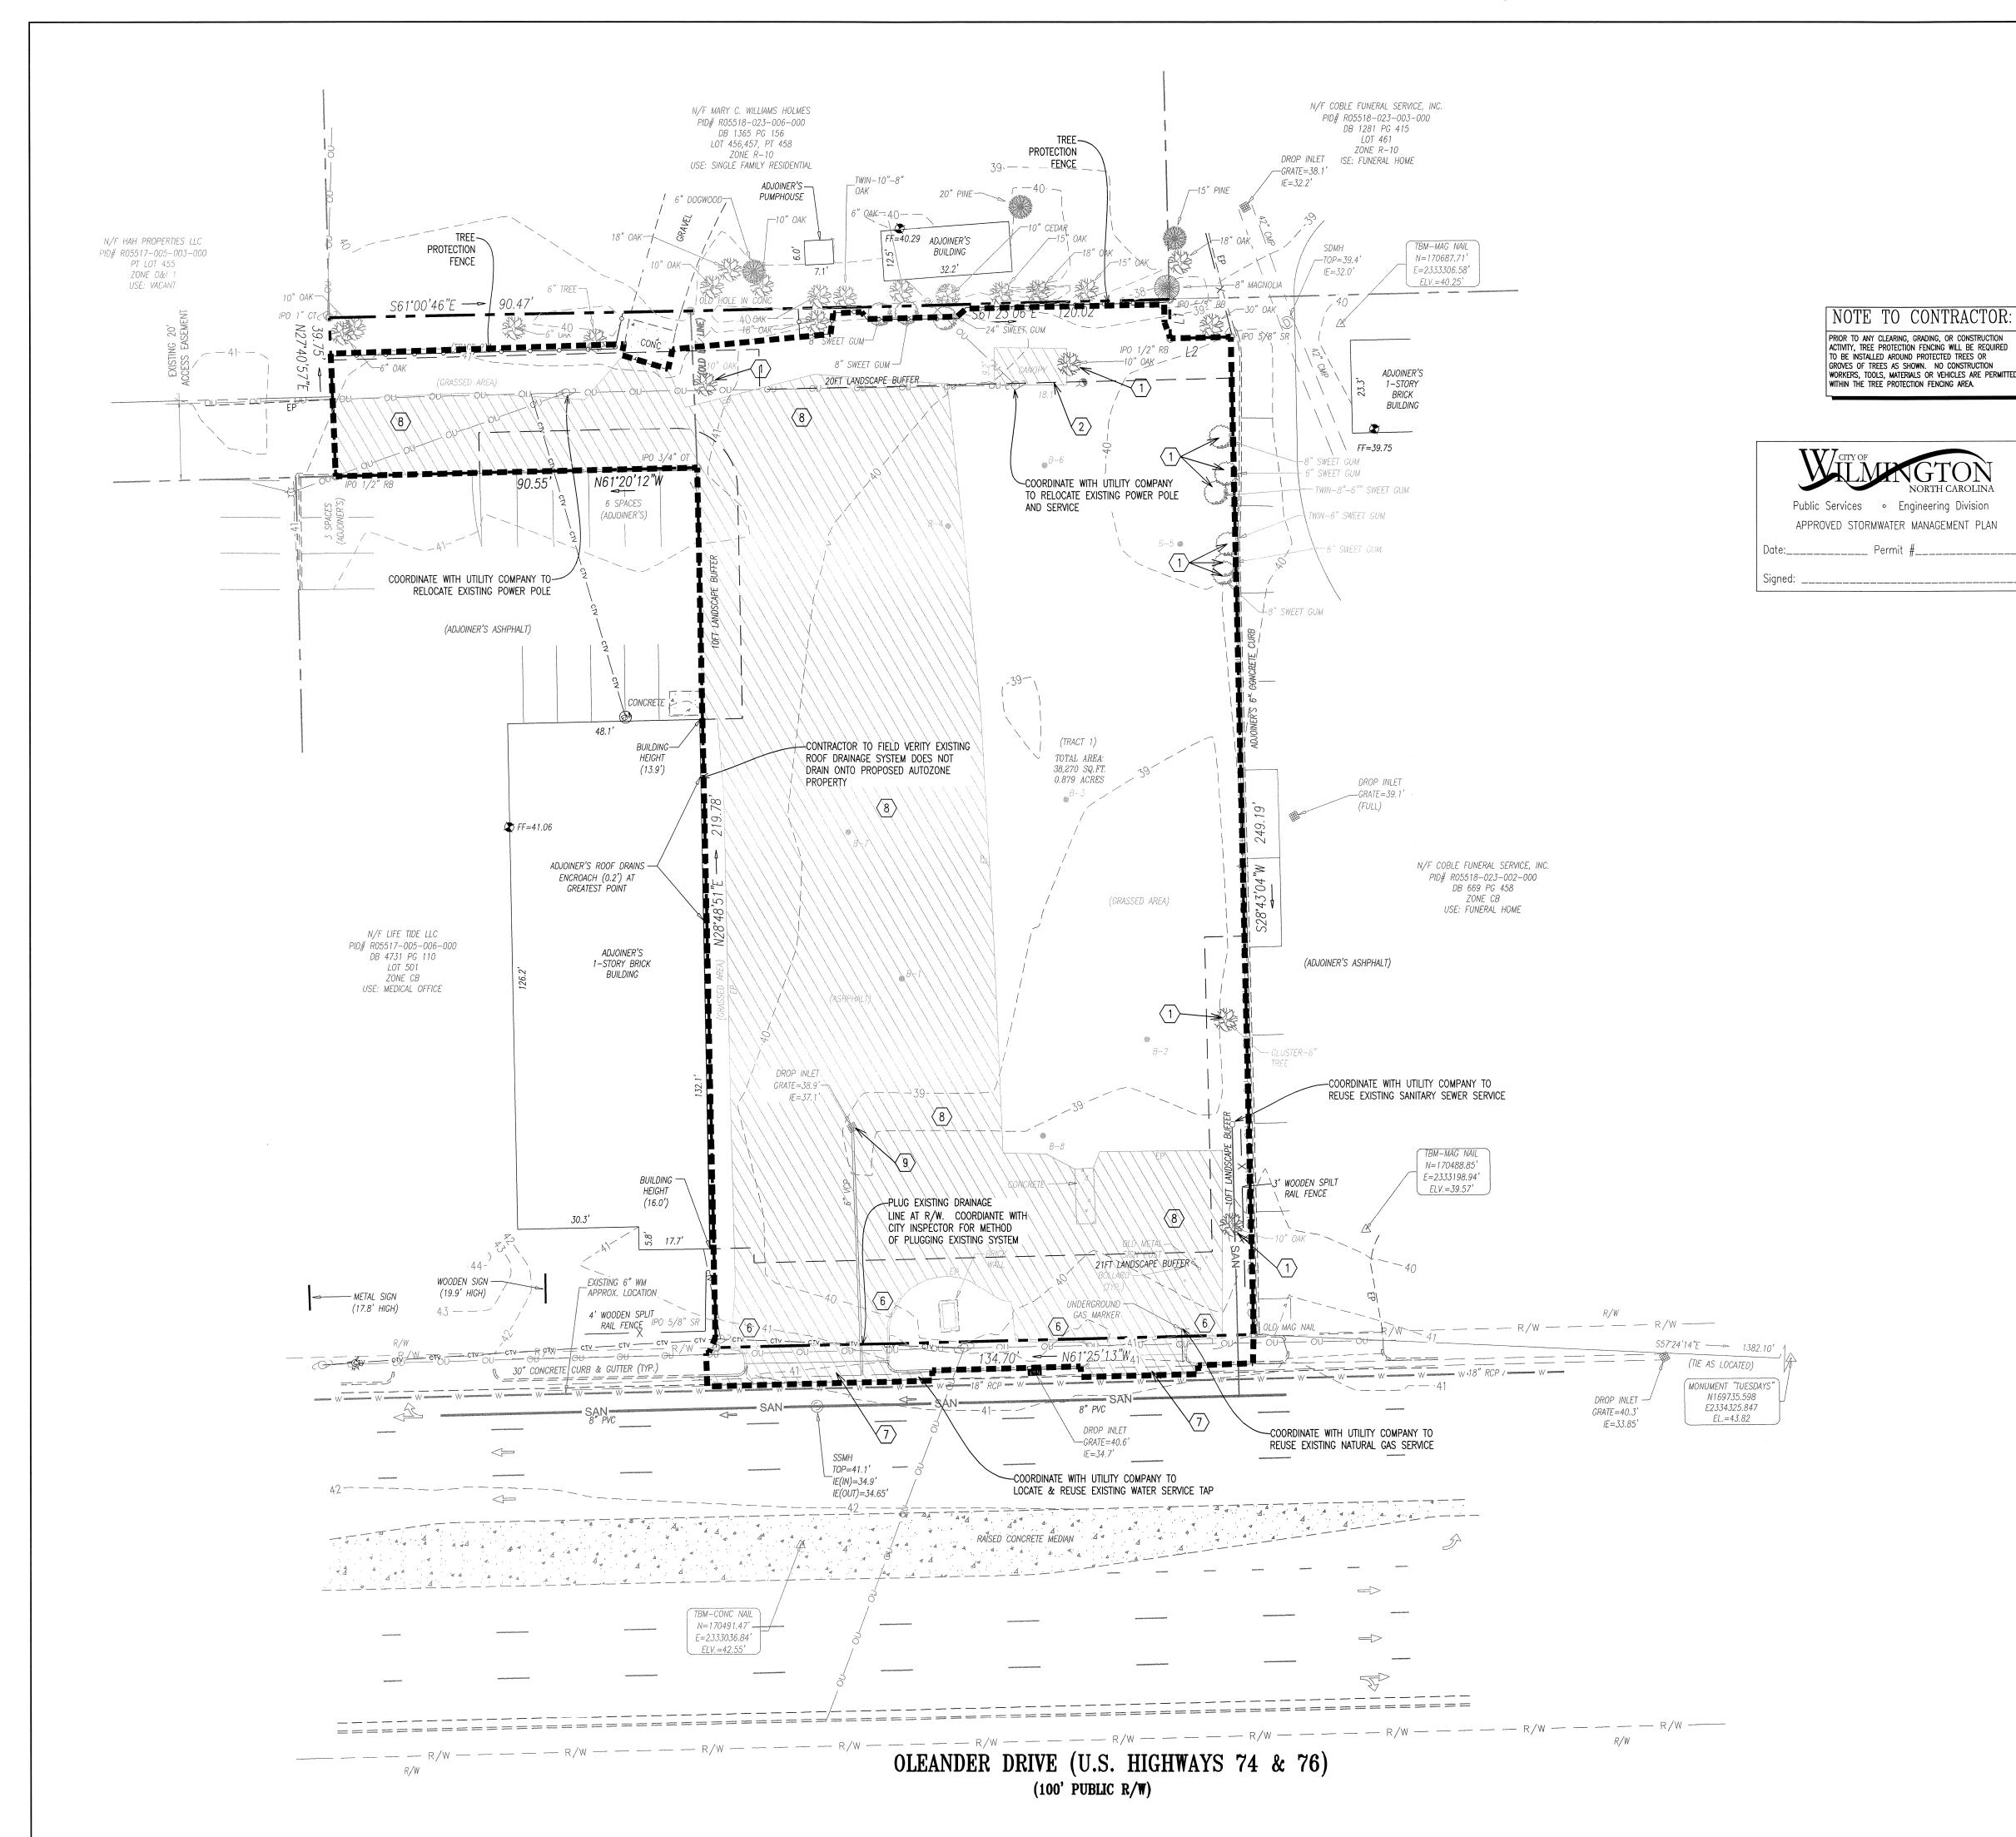








#### CAUTIONARY NOTE

THE LOCATIONS OF ALL EXISTING UNDERGROUND UTILITIES SHOWN ON THIS DRAWING ARE BASED ON ABOVE GROUND EVIDENCE OR INFORMATION GATHERED DURING THE FIELD SURVEY PORTION OF THIS PROJECT. AS SUCH, THIS INFORMATION IS SPECULATIVE IN NATURE ONLY AND SHOULD NOT BE CONSTRUED AS FACT. THERE MAY ALSO BE OTHER EXISTING UNDERGROUND UTILITIES FOR WHICH NO ABOVE GROUND EVIDENCE WAS OBSERVED. THE EXACT LOCATIONS OF THE UNDERGROUND UTILITIES SHALL BE VERIFIED BY THE CONTRACTOR PRIOR TO THE START OF ANY AND ALL CONSTRUCTION.

#### UTILITY STATEMENT

THE UNDERGROUND UTILITIES SHOWN HAVE BEEN LOCATED FROM FIELD SURVEY INFORMATION AND EXISTING DRAWINGS. THE SURVEYOR MAKES NO GUARANTEES THAT THE UNDERGROUND UTILITIES COMPRISE ALL SUCH UTILITIES IN THE AREA, EITHER IN-SERVICE OR ABANDONED. THE SURVEYOR FURTHER DOES NOT WARRANT THAT THE UNDERGROUND UTILITIES SHOWN ARE IN THE EXACT LOCATION INDICATED ALTHOUGH THE SURVEYOR DOES CERTIFY THAT THEY ARE LOCATED AS ACCURATELY AS POSSIBLE FROM INFORMATION AVAILABLE. THE SURVEYOR HAS NOT PHYSICALLY LOCATED THE UNDERGROUND UTILITIES.

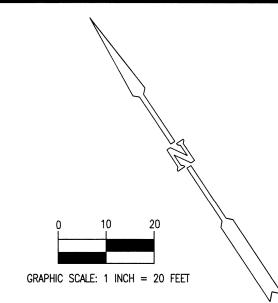

#### KEYNOTES

#### DEMOLITION

- (1) Remove trees and root system
- 2 Remove existing building and foundation
- (3) Remove fence, post, and foundation
- 4 Remove all existing shrubs and debris
- (5) Remove existing sidewalks (6) Remove existing concrete curb
- (7) Remove existing driveway approaches
- 8 Remove existing pavement
- (9) Remove existing utilities

#### GENERAL DEMOLITION NOTES:


- . ALL WORK TO BE ACCOMPLISHED IN STRICT ACCORDANCE WITH ALL LOCAL ORDINANCES, CITY OR STATE.
- WITHIN THE SUBJECT PROPERTY, THE INTENT IS TO HAVE A CLEAN, CLEAR SITE, FREE OF ALL EXISTING ITEMS NOTED TO BE REMOVED IN ORDER TO PERMIT THE CONSTRUCTION OF THE NEW PROJECT.

DEMOLITION NOTES

- ALL ITEMS NOTED TO BE REMOVED BY THE SELLER SHALL BE ACCOMPLISHED PRIOR TO THE CLOSING OF THE REAL ESTATE TRANSACTION. ALL OTHER ITEMS NOTED TO BE REMOVED SHALL BE DONE SO AS PART OF THE CONTRACT FOR GENERAL CONSTRUCTION.
- . REMOVE AND DISPOSE OF ANY SIDEWALKS, FENCES, STAIRS, WALLS, DEBRIS AND RUBBISH REQUIRING REMOVAL FROM THE WORK AREA IN AN APPROVED OFF SITE LANDFILL.
- THE CONTRACTOR SHALL SECURE ALL PERMITS FOR HIS DEMOLITION AND DISPOSAL OF HIS DEMOLITION MATERIAL TO BE REMOVED FROM THE SITE. THE CONTRACTOR SHALL POST BONDS AND PAY PERMIT FEES AS REQUIRED. BUILDING DEMOLITION CONTRACTOR SHALL BE RESPONSIBLE FOR PERMITS AND DISPOSAL OF BUILDING DEMOLITION
- THE DETAILED PLANS MAY NOT REFLECT ALL UTILITIES ON THE SITE OR SURROUNDING STREETS AND PROPERTIES. THE CONTRACTOR SHALL VERIFY LOCATIONS AND EXISTENCE OF UTILITY SERVICES PRIOR TO CONSTRUCTION. THE CONTRACTOR SHALL CALL "DIG SAFE" AT 1-800-344-7233, 72 HOURS PRIOR TO CONSTRUCTION.
- THE CONTRACTOR TO REMOVE ALL UTILITIES TO EXISTING STRUCTURES WHETHER SHOWN OR NOT OR ARRANGE FOR THE APPROPRIATE UTILITY COMPANY TO CUT AND CAP SERVICE PIPING AT THE PROPERTY LINE OR MAIN (AS REQUIRED). ALL SERVICES MAY NOT BE SHOWN ON THIS PLAN. FOR ALL ITEMS NOTED TO BE REMOVED - REMOVE NOT ONLY THE ABOVE GROUND ELEMENTS, BUT ALL
- UNDERGROUND ELEMENTS AS WELL INCLUDING BUT NOT NECESSARILY LIMITED TO: FOUNDATIONS, GRAVEL FILLS, TREE ROOTS, OLD PIPES, ETC.
- 10. BACK FILL ALL EXCAVATIONS RESULTING FROM THE DEMOLITION WORK TO MEET THE REQUIREMENTS FOR FILL OUTLINED IN THE GEOTECHNICAL REPORT.
- THE CONTRACTOR SHALL PROTECT ALL IRON PINS, MONUMENTS AND PROPERTY CORNERS DURING CONSTRUCTION. ANY CONTRACTOR DISTURBED PINS, MONUMENTS, ETC. SHALL BE RESET BY A LICENSED LAND SURVEYOR AT THE EXPENSE OF THE CONTRACTOR.
- 2. THE CONTRACTOR SHALL RESTORE ANY UTILITY STRUCTURE, PIPES, PAVEMENT, CURBS, SIDEWALKS OR LANDSCAPED AREAS DISTURBED DURING DEMOLITION TO THEIR ORIGINAL CONDITION TO THE SATISFACTION.
- 13. ALL BUILDINGS, FOUNDATION WALLS AND FOOTINGS INDICATED ON THIS PLAN TO BE REMOVED FROM SITE. CONTRACTOR SHALL SECURE ANY PERMITS AND PAY ALL FEES AND PERFORM CLEARING AND GRUBBING AND DEBRIS
- REMOVAL PRIOR TO COMMENCEMENT OF GRADING OPERATIONS. 14. ASBESTOS AND ANY OTHER HAZARDOUS MATERIAL SHALL BE REMOVED BY THE GENERAL CONTRACTOR USING A LICENSED HAZARDOUS MATERIAL CONTRACTOR.



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**REVISIONS:** 

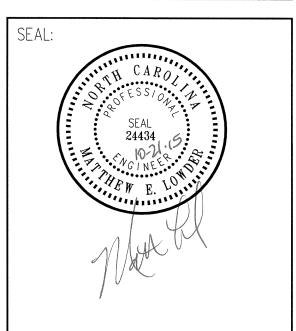
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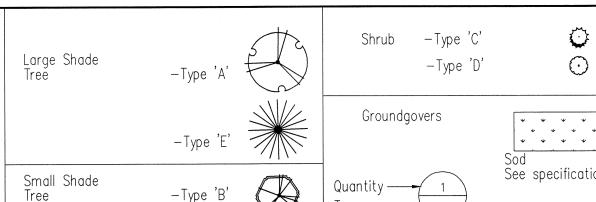
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LAYOUT COORD:	MEL
PLANNING MGR.	MEL
DRAWING BY:	MEL
DATE:	SEPTEMBER 29, 2015
JOB NUMBER:	010048

DEMOLITION PLAN

SHEET NUMBER:




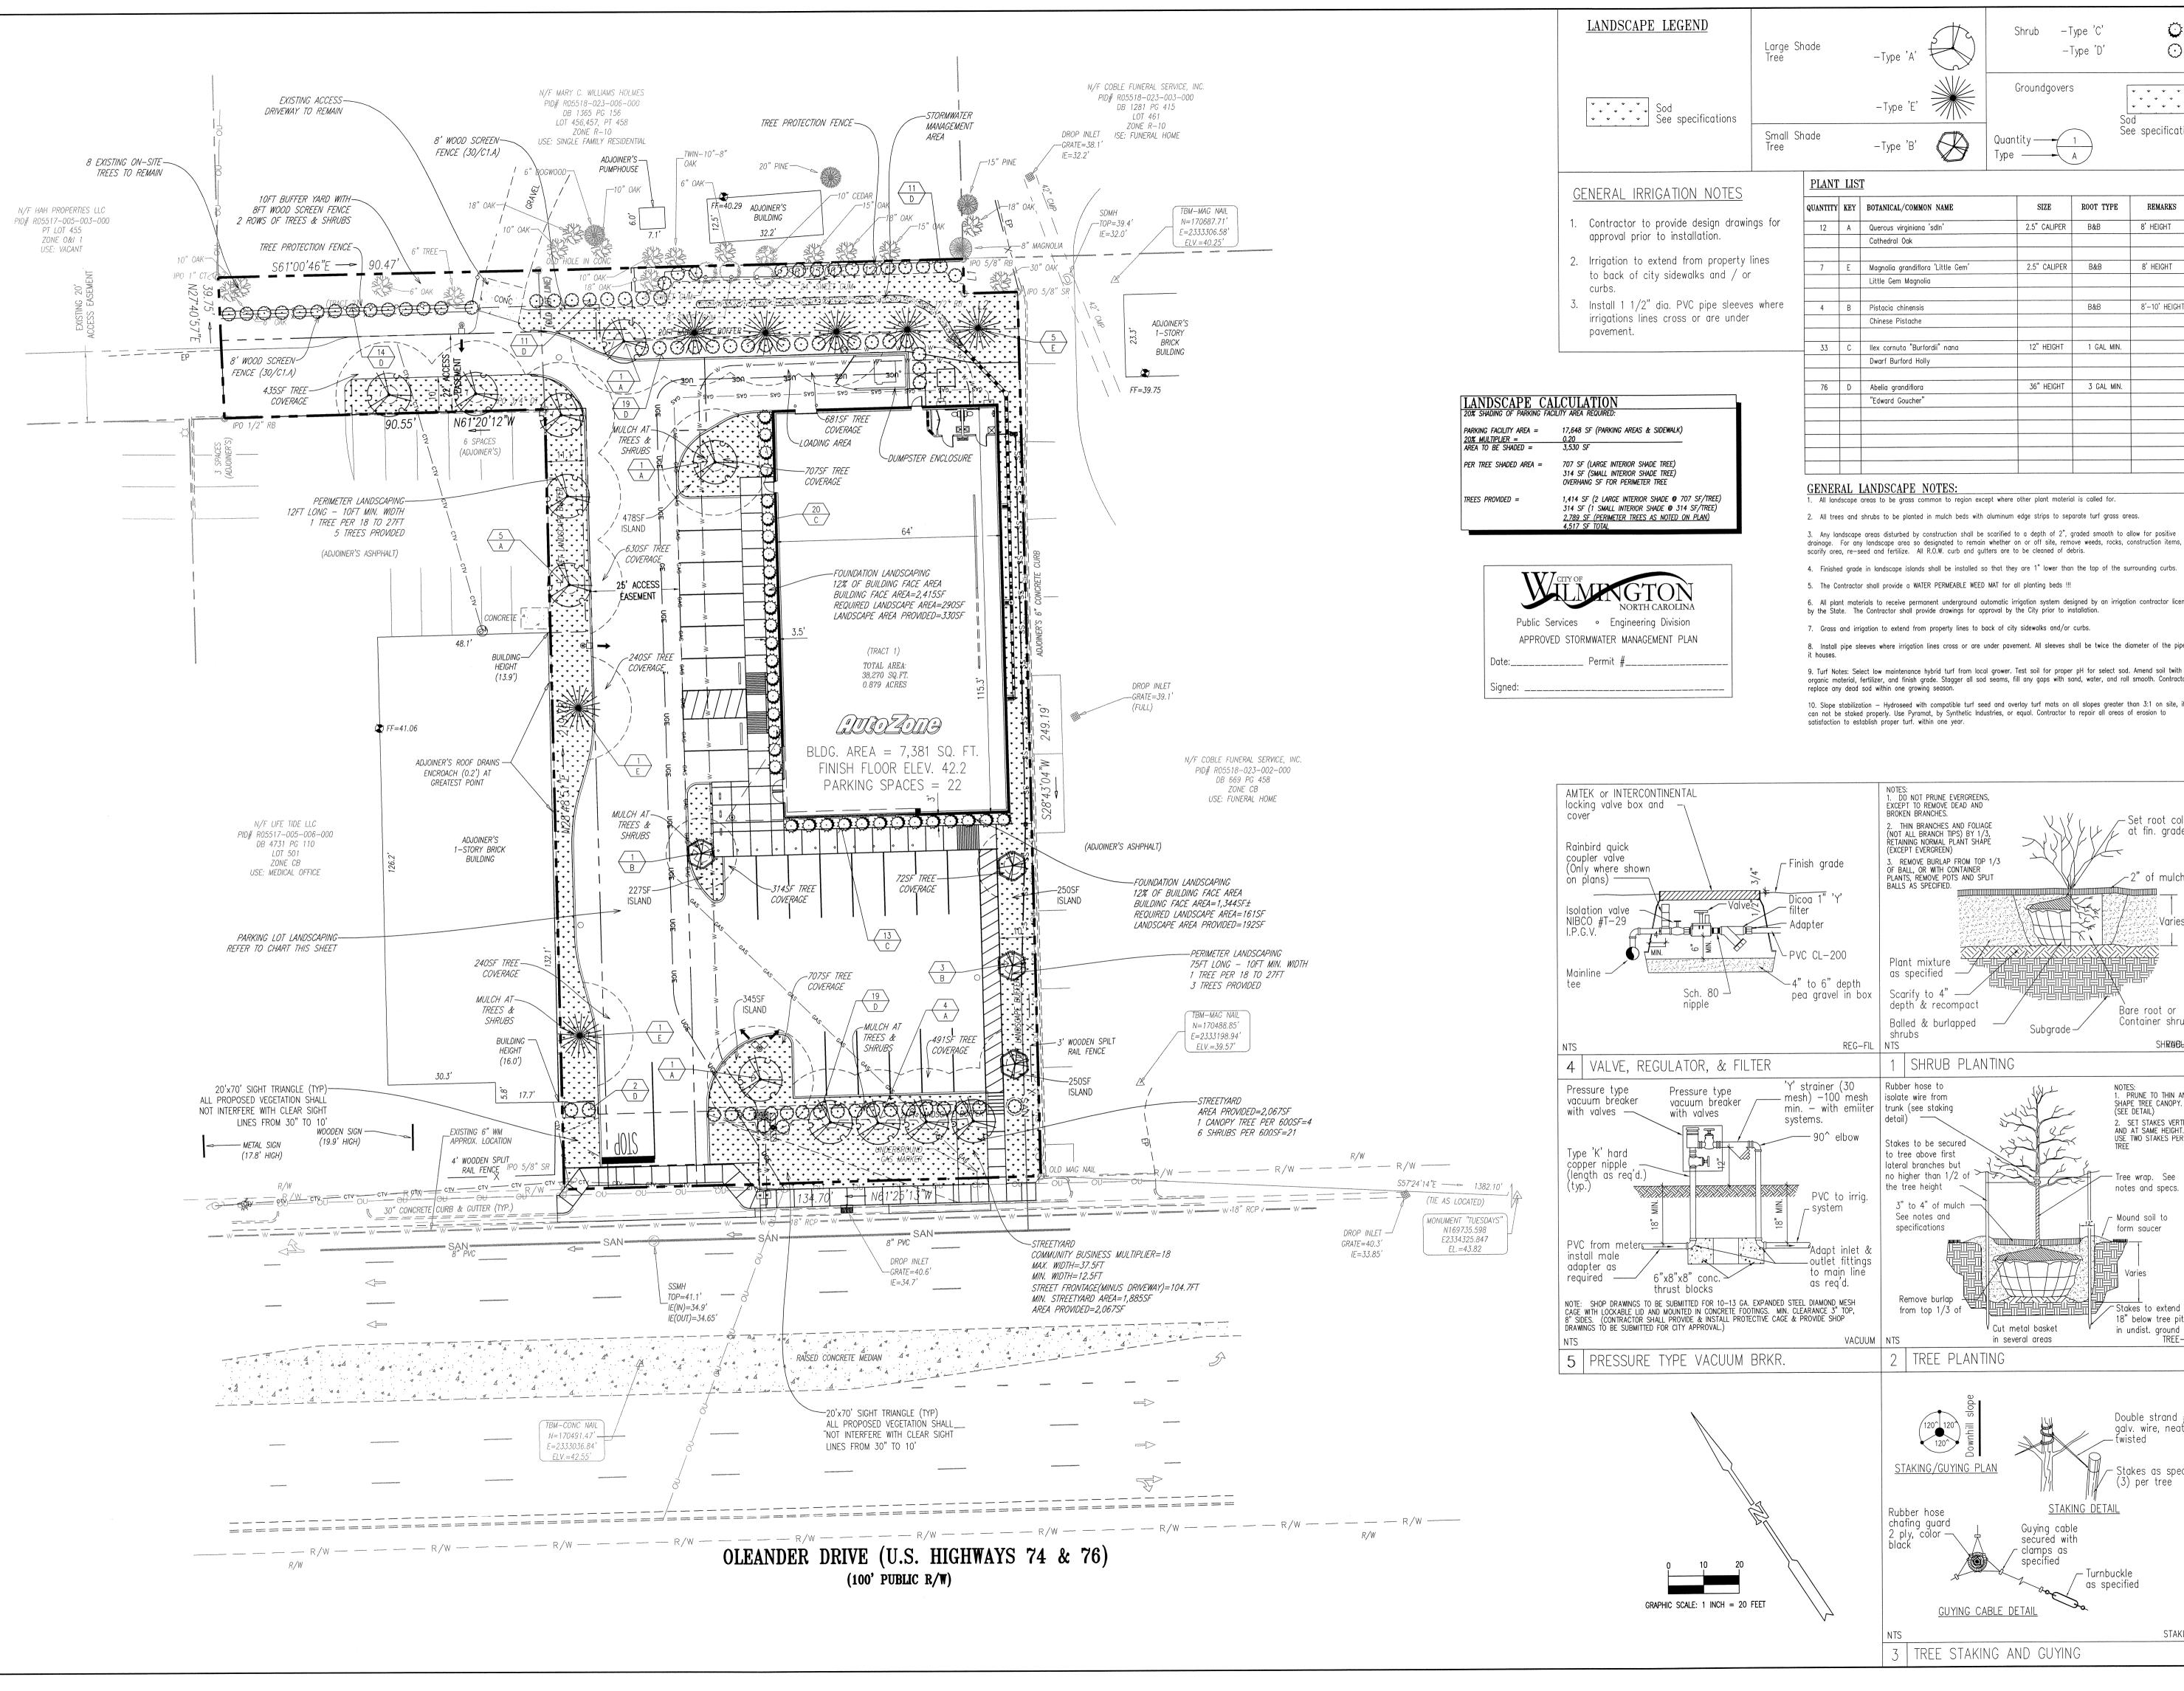


QUANTITY	KEY	BOTANICAL/COMMON NAME	SIZE	ROOT TYPE	REMARKS
12	Α	Quercus virginiana 'sdln'	2.5" CALIPER	B&B	8' HEIGHT
		Cathedral Oak			
7	E	Magnolia grandiflora 'Little Gem'	2.5" CALIPER	B&B	8' HEIGHT
		Little Gem Magnolia			
4	В	Pistacia chinensis		B&B	8'-10' HEIGH
		Chinese Pistache			
33	С	llex cornuta "Burfordii" nana	12" HEIGHT	1 GAL MIN.	
		Dwarf Burford Holly			
76	D	Abelia grandiflora	36" HEIGHT	3 GAL MIN.	
		"Edward Goucher"			

- 2. All trees and shrubs to be planted in mulch beds with aluminum edge strips to separate turf grass areas.
- 3. Any landscape areas disturbed by construction shall be scarified to a depth of 2", graded smooth to allow for positive drainage. For any landscape area so designated to remain whether on or off site, remove weeds, rocks, construction items, etc., scarify area, re—seed and fertilize. All R.O.W. curb and gutters are to be cleaned of debris.
- 5. The Contractor shall provide a WATER PERMEABLE WEED MAT for all planting beds !!!
- 6. All plant materials to receive permanent underground automatic irrigation system designed by an irrigation contractor licensed
- 7. Grass and irrigation to extend from property lines to back of city sidewalks and/or curbs.
- 8. Install pipe sleeves where irrigation lines cross or are under pavement. All sleeves shall be twice the diameter of the pipe(s)
- 9. Turf Notes: Select low maintenance hybrid turf from local grower. Test soil for proper pH for select sod. Amend soil twith organic material, fertilizer, and finish grade. Stagger all sod seams, fill any gaps with sand, water, and roll smooth. Contractor to


10. Slope stabilization - Hydroseed with compatible turf seed and overlay turf mats on all slopes greater than 3:1 on site, if sod can not be staked properly. Use Pyramat, by Synthetic Industries, or equal. Contractor to repair all areas of erosion to

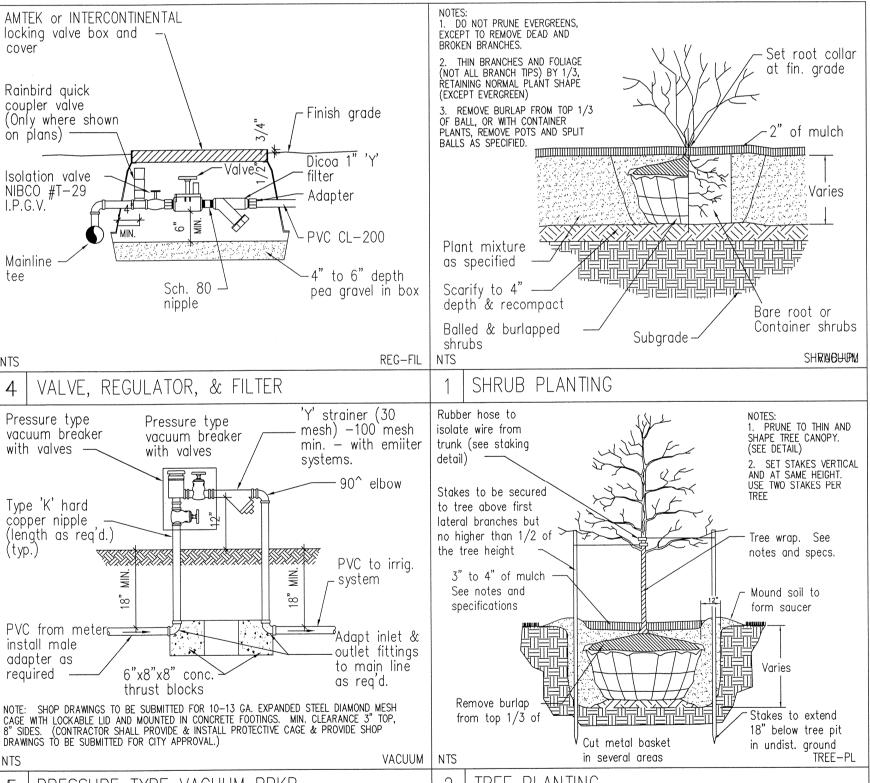

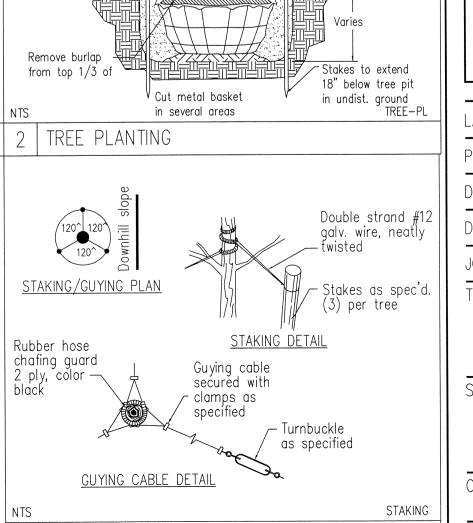



ONSULTANT: RIANGLE SITE DESIGN, PLLC 4006 BARRETT DR, STE 203 RALEIGH, NC 27609 (919) 553-6570 LICENSE #P-0619

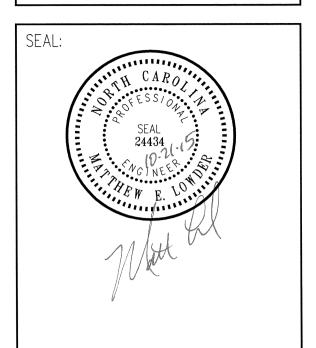

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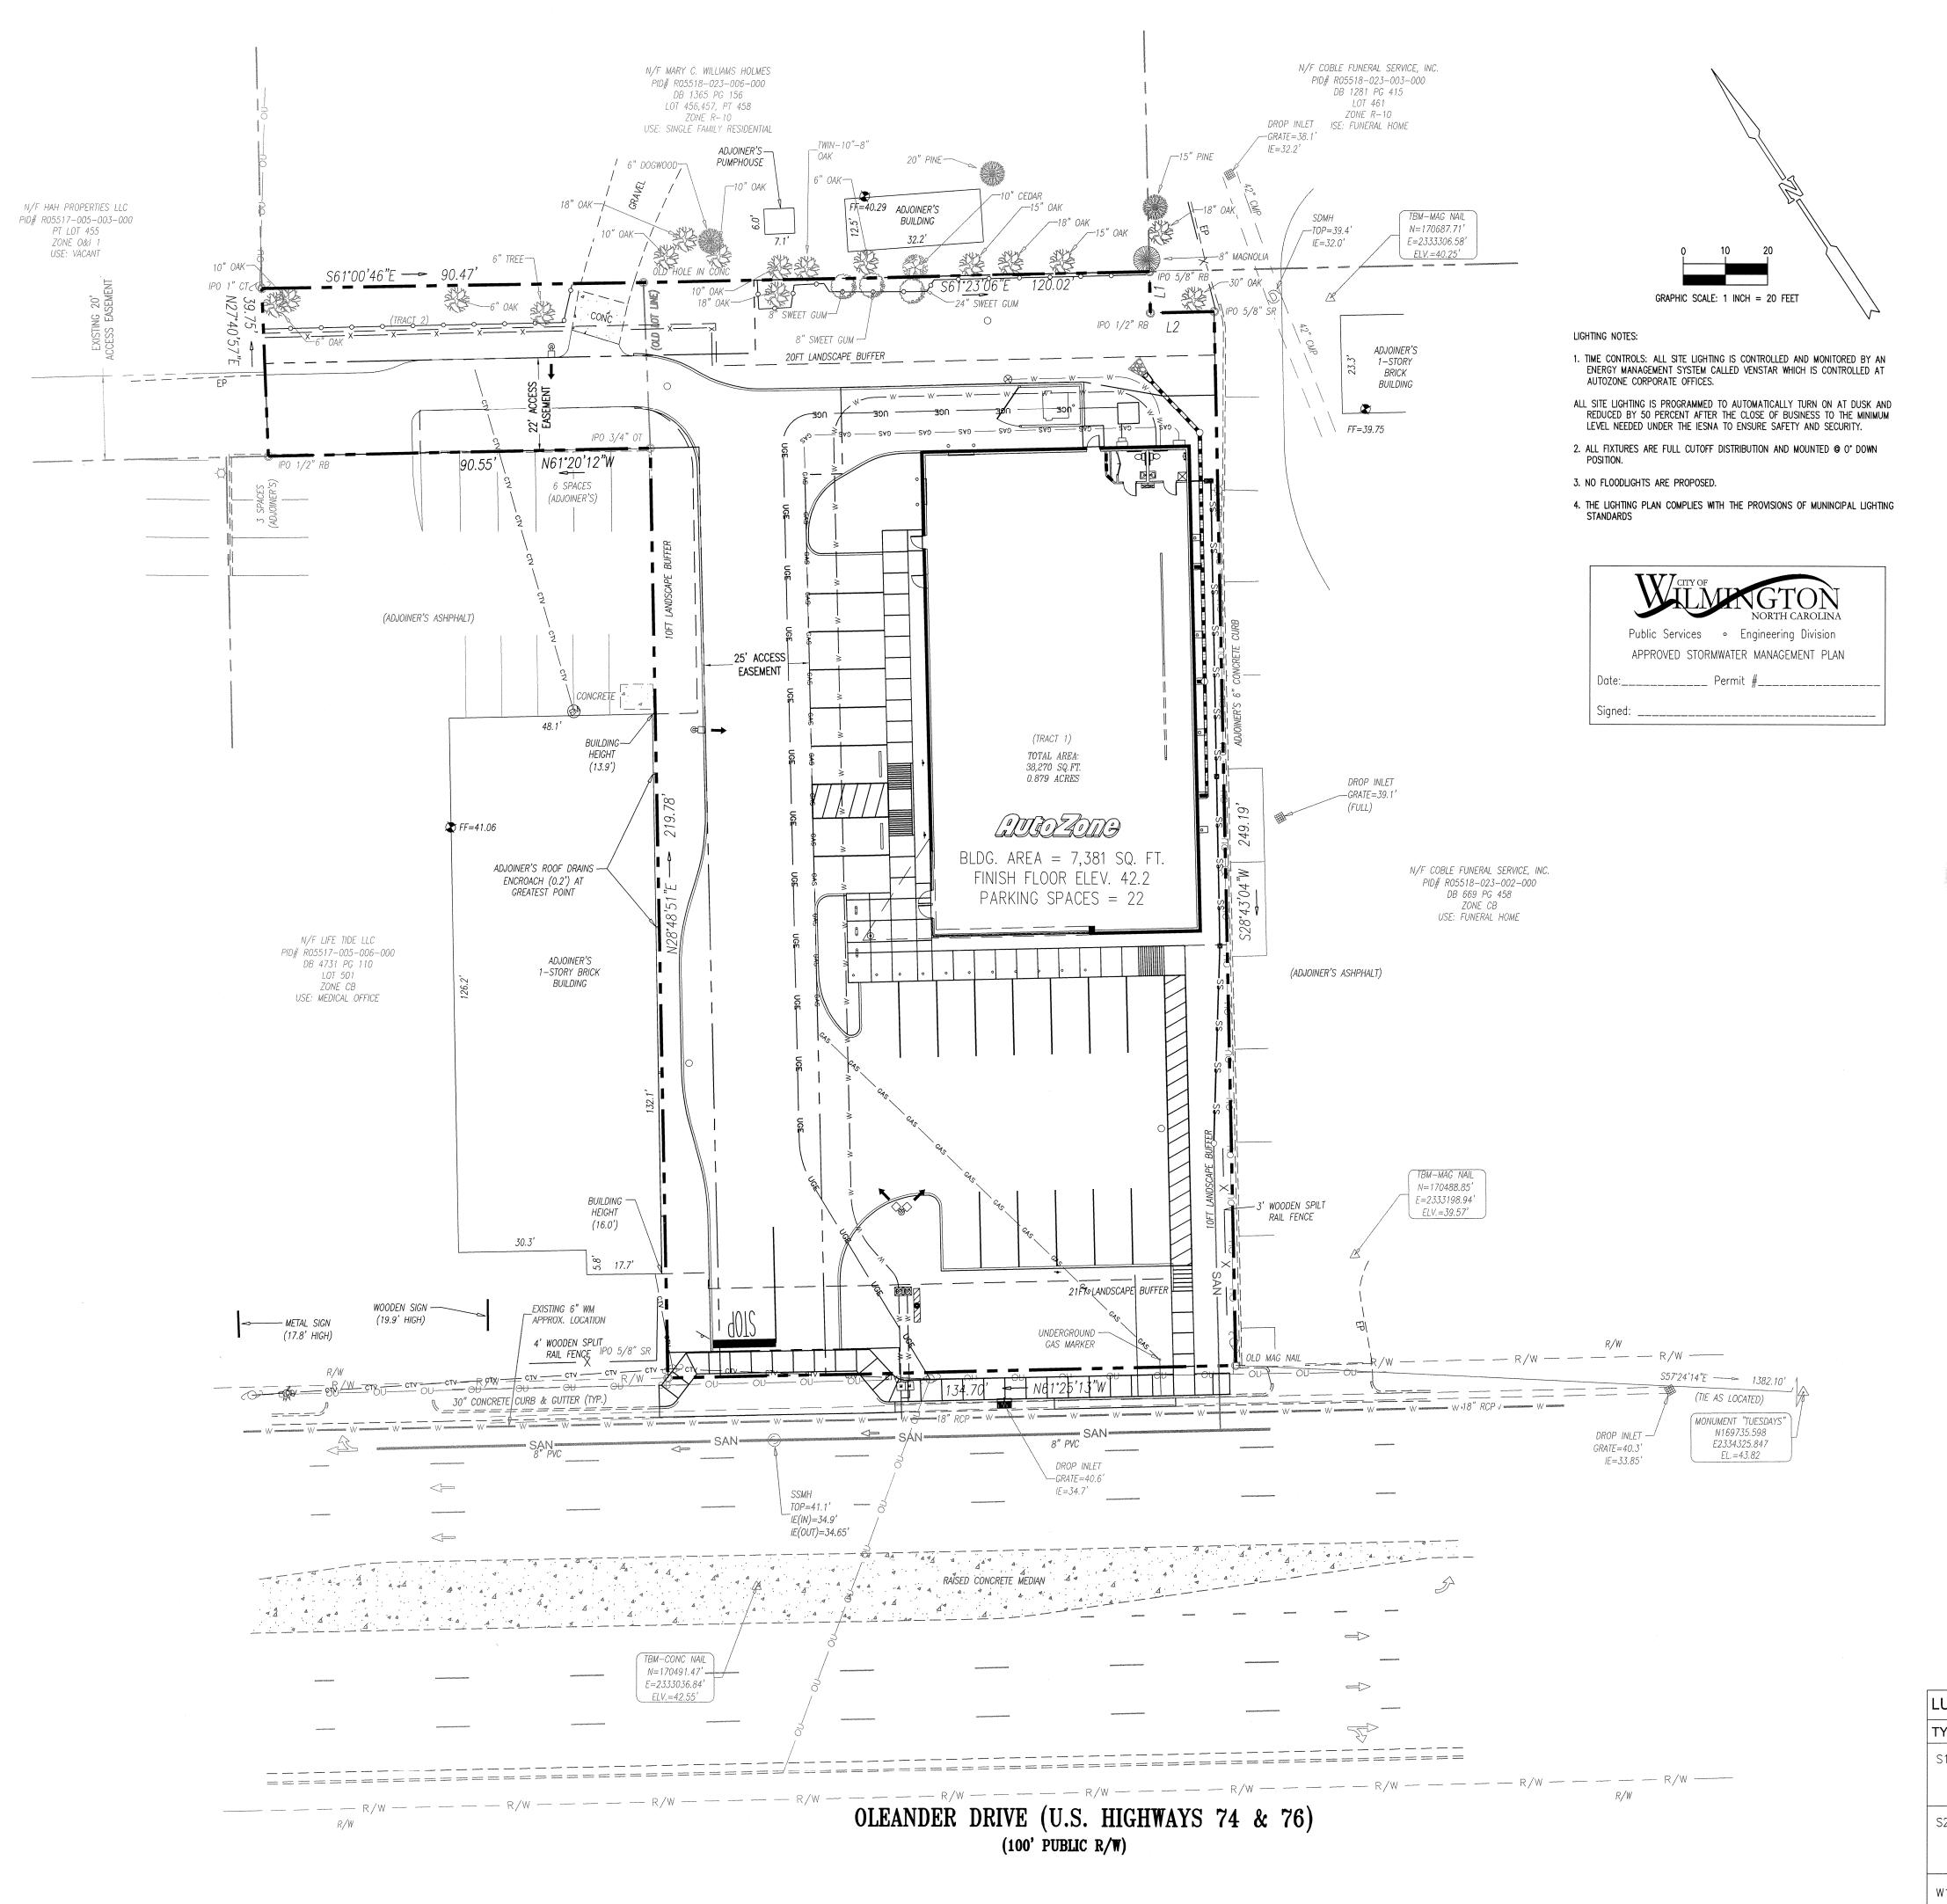
OWNER/DEVELOPER: AUTOZONE DEVELOPMENT, LLC ATTN. WADE DAVIS 123 S. FRONT STREET 3RD FLOOR MEMPHIS, TN 38103-2107 PHONE: (901) 495-8701 FAX: (901) 495-8969 wade.davis@autozone.com For Bidding & Contractor Information Contact: F.W. Dodge Plan Room Tel: (615) 884-1017

REVISIONS: 10/21/15 REVISED PER CITY OF WILMINGTON REVIEW COMMENTS

LAYOUT COORD:	MEL
PLANNING MGR.	MEL
DRAWING BY:	MEL
DATE:	SEPTEMBER 29, 2015
JOB NUMBER:	010048
TITLE:	

LANDSCAPE PLAN

SHEET NUMBER:





Specifications Width: 490 cm

statement even as it blends seamlessly with its The D-Series distills the benefits of the latest in LED technology into a high performance, high efficacy, long-life luminaire. The outstanding photometric performance results in sites with excellent uniformity, greater pole spacing and lower power density. It is ideal for replacing 100 -400W metal halide in pedestrian and area lighting applications with typical energy savings of 65% and expected service life of over 100,000 hours.

EXAMPLE: DSX1 LED 60C 1000 40K T3M MVOLT SPA DDBXD OSX1 LED ADM 4000K F35 hpellistori TAM Type N medium 347 50K SUNGE HTM Forward throw 480 DF Double fuse DELEXID Textured mani-ng Water sensor, 6-15' maning serjek! (2014, 2401, 4801V)<sup>11</sup> CRY 1545 type V very i lod-less entry DNATAD lectured trigger lands TSS Type V short L90 left-plated optics<sup>14</sup> alummann BL30 Switched directing 30% \* TSM Type V medium DWHGID lexared white BLSO Switched cleaning, 50%<sup>1,10</sup> Rso Aight rotated optics\* TSW Type V wide

Top of Pole IESAI shares a unique drilling pattern with the AERIS™ bandy. Specify this daling paters when specifying pales, per the table below. Example: SSA 20 40 BM19AS 10939 DELEGET ESCRETAL PRODUCES SELENCE (NOTE) \*\* Shorting can to ISSNS 301 House-sale should be Williams Tenon Mounting Slipfitter DESCRIPE ADM. U Seema set a charle for AD LED conf. Para El Seguido (1857 TANT TAND SANT TAND (ELEMES SOCIO Minerae-seine shakeld for 60 LEO usual

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Configured with 4000K (40K) provides the shortest lead times. Consult factory for 3000K (60K) and 5000K (50K) lead times.
MACLT driver operates on any line voltage from 120-227W (50K)0 Hzi, Specify 120, 208, 240 or 277 options only when ordering with fusing (SF, DF options). Hot available with single board, 530mA product (30C 530). Hot available with 347 or 480%. Specifies a RCAMMS anabled luminaire with 0-10V dimming capability; PER option registred. Not available with 347 or 450V. Additional histories and services required for RCAMMS deployment must be purchased separately. Call 1-800-442-6745 or email: salestimanservices.nut. Not available with Recuires 40C or 60C. Provides 50/50 harrinates operation via two independent offwers on two separate drouts. N/A with PER, DCR, DMG or

equires an additional switched line. pectifies the Sensor Switch 338, 10 CDP controls see Mestion Sensor Co or details. Dimming driver standard, Not available with DCR or WTB. Specifies the SersorSwitch SSR & COP control: see Motion Sersor Guida for details. Dimming driver standard, Not available with DCR or WTB. Dimming driver standard, MWOLT only, Not available with DCR or WTB. Also available as a separate accessory, see Accessories information. WTB net available with BLSO, BLSO, DS, PIR or PIRH. Singlia fizza (SF) raquinas 120, 277 or 347 voltage option. Double fizza (DF) raquinas 208, 240 or 480 voltage option. Available with 60 LEDs (60C option) only 15 Requires luminates to be specified with PER option. Ordered and shipped as a separate line fram. One Lithonia Way + Conyers, Georgia 20012 + Phone: 900.279.9041 + Fax: 770.918.1209 + www.lehonis.com



LITHONIA LIGHTING.

SPATS/SMIT COSED II Square pole 2M TV in DM TW C. actipore (max Tv fine b)

REPULSAMED USEGED 11 Received goods DNATA in DNATAN'S acception Expect for Enrich!

D-Series Size 1 LED Wall Luminaire

DESIGNATION TO THE PARTY OF THE

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"For an onlyada mounting (APA) only.

Introduction

Back Box (BBW, ELCW) Luminaire (10.2 cm) Weight:

6-3/8" (162cm)

The D-Series Wall luminaire is a stylish, fully integrated LED solution for building-mount pplications. It features a sleek, modern design and is carefully engineered to provide long-lasting,

energy-efficient lighting with a variety of optical and control options for customized performance. With an expected service life of over 20 years of nighttime use and up to 74% in energy savings over comparable 250W metal halide luminaires, the D-Series Wall is a reliable, low-maintenance lighting solution that produces sites that are exceptionally illuminated.

EXAMPLE: DSXW1 LED 20C 1000 40K T3M MVOLT DDBTXD 10157s ISM Nesewation 120° Single tuse DBLXD Black (menghe) 135 Type 8 Short mounting bracket (120, 277V) <sup>a</sup> (-10% dimensing drives (no contrab.) F3M Type iii Medium 240 T Double hase BBW Sather EWHICE Water (DM: 140V) \* (two engines) FAM Type IV Medium mounted back box 180° median Arministi HS House-side DGSMD Sandstone Aght sensor, < 15 mag no <sup>4, 1</sup> TETM Forward Throw DOGETIKO Pertured dark Medium for conduit 150 150 m4 PIRH 180° motion/ambient Shipped separately Aght sensor, 15-30° mag ht <sup>1</sup> DOLEND Testured 520. BSW Blod-deterrent 700 700 mA DNATAD TRANSPORTED 1000 1000 mA (1 A) ALITE PARTY. WG Weeguard\* DWHGXD Textured white externá component extigace) <sup>7</sup> Color temperature VG Vandal guard <sup>3</sup> DZSTAD Restured 30K 3000K 40K 4000K 50% S036%

 MVOLT driver operators on any line violage from 120-277V (90/60 Hz). Specify 120, 208, 240 or 277 options only when ordering with fusing (SF, DF options), or photocontrol (PE option).
 Back box ships installed on fixture. Cannot be fixed installed. Cannot be ordered as an accessory. Photocontrol (PE) requires 120, 206, 240 or 277 voltage option. Not available with motios/ambient light sensors (PIR or PIRA). 4 Specifies the Server Switch SBR-10-CHY control see Motion Server Guida for details, includes ambient light sensor. Not available with "PE" option (button type photocell). Disweing driver standard.

5. Specifies the Sensor Switch SSR-6-COP control see Medion Sensor Gulderfor details, includes ambient light sensor. Not available with "E" option (button type photocell). Disweining driver standard.

6. Not available with 20 LED/1000 in A configuration (DSAW1 LED 2001 1000). 7 Not compatible with condeit entry applications. Not available with BBM mounting option.
8 Single tisse (SF) requires 120 or 277 voltage option. Double tisse (DF) requires 206 or 240 voltage option.

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9 Also available as a separate acceptory, see Accessories Information.


Accessories Ordered and a hipped separately. DSTWP5 U House-side shield lame per light-engine! DOENTOW U Bird-decorrect spikes DINTELL Wingard accessory DOWN W. Virginia post accessing

One Lithonia Way + Conysas, Georgia 20012 + Phona: 200.279.8041 + Fax: 770.918.1209 + www.lithonia.com

LUMINAIRE SCHEDULE						
TYP	SYMBOL	DESCRIPTION	LAMP	LUMENS	LLF	QTY
S1	œ_	LITHONIA - DSX1 LED 60C IES FULL CUTOFF DISTRIBUTION MOUNTED 0° DOWN POSITION MOUNTED HEIGHT = 28'-0"	LED - 209 WATTS	ABSOLUTE	0.95	2
S2	<b>@</b> D	LITHONIA - DSX1 LED 60C IES FULL CUTOFF DISTRIBUTION MOUNTED 0° DOWN POSITION MOUNTED HEIGHT = 28'-0"	LED - 418 WATTS	ABSOLUTE	0.95	1
W1	$\triangleright$	LITHONIA - DSW1 LED 10C IESNA FULL CUTOFF DISTRIBUTION MOUNTED 0° DOWN POSITION MOUNTED HEIGHT = 12'-0"	LED — 40 WATTS	ABSOLUTE	0.95	



CONSULTANT: TRIANGLE SITE DESIGN, PLLC 4006 BARRETT DR, STE 203 RALEIGH, NC 27609 (919) 553-6570 LICENSE #P-0619

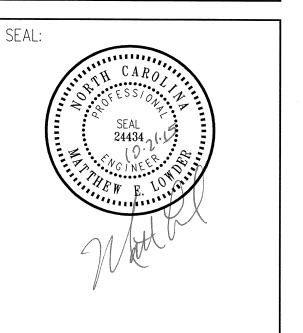

OWNER/DEVELOPER: AUTOZONE DEVELOPMENT, LLC ATTN. WADE DAVIS 123 S. FRONT STREET 3RD FLOOR MEMPHIS, TN 38103-2107 PHONE: (901) 495-8701 FAX: (901) 495-8969 wade.davis@autozone.com For Bidding & Contractor Information Contact: F.W. Dodge Plan Room Tel: (615) 884-1017

REVISIONS: 10/21/15 REVISED PER CITY OF WILMINGTON REVIEW COMMENTS

1		
	LAYOUT COORD:	MEL
	PLANNING MGR.	MEL
	DRAWING BY:	MEL
	DATE:	SEPTEMBER 29, 2015
	JOB NUMBER:	010048

LIGHTING PLAN

SHEET NUMBER:

<u>DATA</u>

ZONED: CB - COMMUNITY BUSINESS

SETBACK REQUIREMENTS: FRONT - 20 FEET SIDE - O FEET REAR - 10 FEET

MAXIMUM BUILDING HEIGHT: 45 FEET

MINIMUM LOT WIDTH: 80' MINIMUM LOT SIZE: 1/2 ACRES

municode.com

MAXIMUM NUMBER OF STORIES: 3

AUTOZONE IS A PERMITTED USE FOR THIS ZONING DISTRICT.

SOURCE OF DATA CITY OF WILMINGTON, N.C.

ACCESS NOTE

ACCESS TO SUBJECT PROPERTY VIA PUBLIC

RIGHT-OF-WAY OF OLEANDER DRIVE

TOTAL AREA

38,270 SQ.FT.

0.879 ACRES

PARKING REQUIREMENTS

REQUIRED NUMBER

N/A

OF SPACES

GROSS FLOOR AREA OF

ESTABLISHMENT IN S.F.

LESS THAN 5,000

5,000 TO 24,499

25,000 TO 49,999

50,000 TO 99,000

100,000

ACCORDING TO THE FEDERAL EMERGENCY MANAGEMENT AGENCY'S FLOOD INSURANCE RATE MAP, NEW HANOVER COUNTY, NORTH CAROLINA, WITH AN EFFECTIVE DATE OF APRIL 3, 2006, THE PROPERTY SURVEYED AND SHOWN HEREON LIES WITHIN ZONE "X" PER COMMUNITY MAP NO. 3720313700J. CITY OF WILMINGTON, NORTH CAROLINA NUMBER 370171

FLOOD ZONE

REFERENCE PLAT

PLAT ENTITLED "ALTA/ACSM LAND TITLE SURVEY FOR MB ONE CAPITAL, LLC, PREPARED BY PATRICK C. BRISTOW LAND SURVEYING, PC, DATED OCTOBER 9, 2013

TAX ASSESSOR PARCEL NO.

R05518-023-001-000

BASIS OF BEARINGS

NORTH CAROLINA STATE PLANE COORDINATES WERE USED AS THE BASIS OF BEARINGS FOR THIS SURVEY.

ENCROACHMENTS/PROJECTIONS

(A) ADJOINER'S CONCRETE CURB ENCROACHES 0.5'

TITLE LEGAL DESCRIPTION

MISCELLANEOUS NOTES:

1. NORTH CAROLINA STATE PLANE COORDINATES WERE USED AS THE BASIS OF BEARINGS FOR THIS SURVEY.

2. SUBJECT PROPERTY APPEARS TO DRAIN INTO A PUBLIC RIGHT OF WAY, UNLESS OTHERWISE SHOWN OR NOTED.

3. THERE IS OBSERVABLE EVIDENCE OF EARTH MOVING WORK, BUILDING CONSTRUCTION OF BUILDING ADDITIONS WITHIN RECENT MONTHS ON SUBJECT

4. REFERENCE DEED: DB 5557 PG 0465

PROPERTY.

5. THERE ARE NO KNOWN CHANGES IN STREET RIGHT OF WAY LINES, EITHER COMPLETED OR PROPOSED, AND AVAILABLE FROM THE CONTROLLING JURISDICTION.

6. THERE IS OBSERVABLE EVIDENCE OF RECENT STREET OR SIDEWALK CONSTRUCTION OR REPAIRS.

7. THERE IS NO OBSERVABLE EVIDENCE OF SITE USE AS A SOLID WASTE DUMP, SUMP OR SANITARY LAND FILL

8. THERE IS NO OBSERVED EVIDENCE OF THE LOCATION OF CEMETERIES AND BURIAL GROUNDS.

9. MAP PIN: R05518-023-001-000

10. ALL DRIVES/PARKING LOTS ARE ASPHALT PAVING UNLESS OTHERWISE NOTED

11. CURRENT OWNER OF RECORD: INDEPENDENCE GENE LLC

12. DIRECT ACCESS TO SUBJECT PROPERTY VIA PUBLIC RIGHT OF WAY OF OLEANDER DRIVE

13. STREET ADDRESS NOT POSTED AT TIME OF FIELD SURVEY.

14. RECORD DESCRIPTION AS PROVIDED DOES FORM A MATHEMATICALLY CLOSED

15. OBSERVED UTILITIES EITHER ENTER SUBJECT PROPERTY FROM PUBLIC RIGHT OF WAY OR THROUGH DEDICATED EASEMENTS, UNLESS OTHERWISE NOTED HEREON

16. BY OBSERVED EVIDENCE ONLY, THE SUBJECT PROPERTY DOES SERVE ADJOINING PROPERTY FOR UTILITIES, DRAINAGE, STRUCTURAL SUPPORT OR INGRESS OR EGRESS

17. NO EVIDENCE OF POTENTIAL WETLANDS WERE OBSERVED ON THE SUBJECT PROPERTY AT THE TIME THE SURVEY WAS CONDUCTED, NOR HAVE WE RECEIVED ANY DOCUMENTATION OF ANY WETLANDS BEING LOCATED ON THE SUBJECT

W + ENOT TO SCALE VICINITY MAP

#### SURVEYORS CERTIFICATE

THIS IS TO CERTIFY THAT THIS MAP OR PLAT AND THE SURVEY ON WHICH IT IS BASED WERE MADE IN ACCORDANCE WITH THE 2011 MINIMUM STANDARD DETAIL REQUIREMENTS FOR ALTA/ACSM LAND TITLE SURVEYS, JOINTLY ESTABLISHED AND ADOPTED BY ALTA AND NSPS, AND INCLUDES ITEMS 1, 2, 3, 4, 5, 6(B), 7(A) 7(B)(1), 7(C), 8, 9, 10(A), 11(A), 13, 14, 16, 17, 18 AND 21 OF TABLE A THEREOF. THE FIELD WORK WAS COMPLETED ON JANUARY 20, 2015

DATE OF PLAT OR MAP: 1-23-15

BY: T.A. SHERARD, P.L.S.

REGISTRATION NO: L-3344 STATE OF NORTH CAROLINA

THE PROPERTY DESCRIBED AND SHOWN HEREON IS THE SAME PROPERTY DESCRIBED IN [INSERT NAME OF TITLE COMPANY] TITLE COMMITMENT NO. \_\_\_\_ DATED \_\_\_\_\_\_, 201\_\_\_.

> TEL 🖸 TELEPHONE PEDESTAL EM ELECTRIC METER

CB CATCH BASIN

DI I DROP INLET

x90.0 ELEVATION

ELEC TRANS

BL BUILDING LINE CL CENTERLINE CMP CORRUGATED METAL PIPE CT CRIMP TOP DE DRAINAGE EASEMENT EP EDGE OF PAVEMENT

IPO IRON PIN OLD-O IPS IRON PIN SET-O N&C NAIL & CAP OT OPEN TOP RB REBAR RCP REINFORCED CONC PIPE R/W RIGHT OF WAY

SD STORM DRAIN

SSE SS EASEMENT ● B-1 SOIL BORING

DESIGN, INC.

No. C00122

SS SANITARY SEWER

FIRE HYDRANT GAS METER GV ⋈ GAS VALVE LP 🌣 LIGHT POLE PP DPOWER POLE GP - GUY ANCHOR SDMH D SD MANHOLE SSMH S SS MANHOLE TMH T TELEPHONE MANHOLE CO • CLEAN OUT

TC/BC TOP/BOTTOM CURB TW/BW TOP/BOTTOM WALL VCP VITRIFIED CLAY PIPE W)WATER METER WV∭WATER VALVE ---CTV--- CABLE TV ---X--- FENCE LINE ---FOC--- FIBER OPTIC CABLE ----GAS---- GAS LINE ----OHP--- OVERHEAD POWER ----OHT--- OVERHEAD TELEPHONE ----SD---- STORM DRAIN -----SS---- SANITARY SEWER -----UGP---- UNDERGROUND POWER

ACJ/DRA

-----W----- WATER LINE

CATV ■ CABLE TV PEDESTAL

SHEET 1 OF 2

"ALTA / ACSM LAND TITLE SURVEY" FOR

**AUTO ZONE** 

3913 OLEANDER DRIVE NEW HANOVER COUNTY WILMINGTON, NORTH CAROLINA

BM/JA 1/22/2015 1"=20'

CIVIL ENGINEERS - SURVEYORS - LANDSCAPE ARCHITECTS

800 E. WASHINGTON ST, STE. B GREENVILLE, SC 29601 PH: (864)271-0496 FAX: (864)271-0402 www.sitedesign-inc.com

NOT FOR CONSTRUCTION

REVISION

S150022

( IN FEET )

1 inch = 20 ft.

GRAPHIC SCALE

